

PLAN VIEW: EXISTING GROUND PLAN



PLAN VIEW: EXISTING UPPER PLAN SCALE 1:100



PICTURE 1



PICTURE 2



PICTURE 3







PICTURE 4 PICTURE 5

PICTURE 6

WENDY HOUSE WINDOW & DOORS SCHEDULE	F.F.L	770 1540 1540 1540 1540 770	1598 1558 819	770 1885 1320	3715	000
SCH	WINDOW NUMBER	EAST ELEVATION, 3x DOUBLE DOORS - W1	NORTH ELEVATION, 1x DOUBLE DOOR - W2	SOUTH ELEVATION - W3	W4	W5 x 2
DY H	FRAME MATERIAL	ALUMINUM_CURTAIN FRAME DETAILS	ALUMINUM_CURTAIN FRAME DETAILS	ALUMINUM_CURTAIN FRAME DETAILS	ALUMINUM	ALUMINUM
	FRAME TYPE	FIXED	FIXED	FIXED	FIXED	FIXED
NEW	GLAZING MATERIAL	SAFETY GLASS	SAFETY GLASS	SAFETY GLASS	SAFETY GLASS	SAFETY GLASS
'	NO. OF SIDES SUPPORTED	2 SIDES	2 SIDES	2 SIDES	2 SIDES	2 SIDES
	GLAZING PANE MIN. THICKNESS	6mm	6mm	6mm	3mm	4mm
	GLAZING PANE MAX. AREA	27.3 / 2 = 13.65m ²	11.7 / 2 = 5.85m ²	5.9 / 2 = 2.95m ²	4.4m²	1.2 / 2= 0.6m ²

GENERAL NOTES: 1. ALL MATERIALS & WORKMANSHIP TO BE IN ACCORDANCE WITH S.A.B.S. SPECIFICATIONS AND CODES OF PRACTICE. 2. READ THIS DRAWING IN CONJUNCTION WITH THE ENGINEERS, LAND SURVEYOR OR OTHER SPECIALISTS DRAWINGS & DETAILS, WHICHEVER MAY BE APPLICABLE. 3. THE CONTRACTOR SHALL NOTIFY THE SUPERVISING CONSULTANT AT LEAST 24 HOURS IN ADVANCE OF COMMENCING ANY SECTION OF WORK. 4. SHOULD ANY DISCREPANCY EXIST BETWEEN ANY DIMENSIONS AND\OR DETAILS AND\OR THE SPECIFICATION THE CONSULTANT SHALL BE NOTIFIED WITHOUT DELAY AND HE WILL TAKE THE FINAL DECISION. 5. SHOULD DEVIATION FROM THE DETAILS BE DESIRED THE CONSULTANTS WRITTEN

AND HE WILL TAKE THE FINAL DECISION.

5. SHOULD DEVIATION FROM THE DETAILS BE DESIRED THE CONSULTANTS WRITTEN APPROVAL SHALL BE OBTAINED BEFOREHAND.

6. ALL STIPULATIONS OF THE LOCAL AUTHORITY AND\OR STATUTORY BODY WITH RESPECT TO CONSTRUCTION AND\OR THE SITE AND THE LIKE, SHALL BE STRICTLY ADHERED TO.

7. ONLY THE DRAWING WITH THE MOST RECENT REVISION WILL BE VALID, UNLESS IT IS REPLACED BY A WRITTEN INSTRUCTION.

8. ONLY WRITTEN DIMS AND\OR LEVELS SHALL BE USED.

9. FIREWALLS MUST ALWAYS BE 220MM THICK WALLS.

10. DAMPCOURSE UNDER ALL WINDOW SILLS AND WALLS.

12. ALL ELECTRICAL AND PLUMBING WORK MUST BE CARRIED OUT IN ACCORDANCE

WITH LOCAL AUTHORITY REGULATIONS.

13. RAFTERS MUST BE BOLTED AT ALL JUNCTIONS.

14. PURLINS-RAFTERS CONNECTIONS MUST BE TIED WITH SUITABLE WIRE.

15. ALL WORK MUST BE CARRIED OUT STRICTLY IN ACCORDANCE TO DIMENSIONS GIVEN.

11. CONCRETE RAINWATER CHANNELS UNDER ALL RAINWATER PIPES.

16. ALL INTERNAL PLASTER MUST HAVE A SMOOTH FINISH.
17. ALL WINDOWS MUST BE APPROVED DESIGN.
18. ALL WALLS LONGER THAN 2500M MUST BE PROVIDED WITH BRICKFORCE IN EVERY THIRD LAYER.

PURLINS @ MAX. 600 mm C/C ON APPROVED DAMP PROOF MEMBRANE ON TIMBER TRUSSES ON TIMBER WALL PLATES.

20. CONCRETE BRICKS WITH BRICKFORCE AT EVERY 3 COURSES TO BE STEEL FLOAT PLASTERED INTERNALLY WITH 2 COATS PAINT. WOOD FLOAT PLASTER EXTERNALLY WITH PRIMER & BONDING LIQUID, UNDERCOAT, FILLERCOAT AND 2 FINAL COATS

19. APPROVED CORRUGATED ROOF SHEETING @ 20° PITCH ON 38 x 38 TIMBER

PAINT. PRECAST CONCRETE LINTOLS ABOVE WALL OPENINGS.
21. ALUMINIUM WINDOWS WITH GLASS TO COMPLY WITH NN2 & NN3 OF NBR'S.
22. 12MM RHINOBOARD CEILING BOARD FIXED TO 38X38MM SA PINE BRANDERS AT 400MM CENTRES TO BE SKIMMED AND PAINTED. MOULDED CORNICES TO CLIENT'S

SPECIFICATIONS


23. FLOOR FINISHES TO OWNERS CHOICE. GROUND FLOOR TO BE 25MM CEMENT SCREED ON 100MM REINFORCED CONC. SURFACE BED TO ENGINEERS DETAILS WITH BRC MESH ON SABS APPROVED DPM ON WELL COMPACTED & POISONED SOIL. UPPER FLOOR SLAB SIZE TO BE SPECIFIED BY ENGINEER.


24. MOULDED SKIRTINGS TO MATCH EXISTING.
25. SMOOTH PLASTER & PAINT AS SHOWN.
26. SMOOTH PLASTER & PAINT ON DOOR AND WINDOW SURROUNDS.
27. DAMP PROOF MEMBRANE BY SPECIALIST.


28. ALUMINIUM RAIN WATER GOODS.
29. RETAINING WALLS TO ENG. DETAIL & SUBJECT TO SITE CONDITIONS.
30. 100Ø PVC SEWER PIPE.
31. 100Ø PVC SEWER PIPE ON ANCHOR BLOCKS.

31. 1000 PVC SEWER PIPE ON ANCHOR BLOCKS.
32. STORMWATER CHANNEL WITH STEEL GRATING.
33. CONC. BEAM TO ENGINEERS DETAIL.

34. TIMBER BEAM TO ENG. DETAIL.
35. 100MM PLASTER BAND AROUND WIND

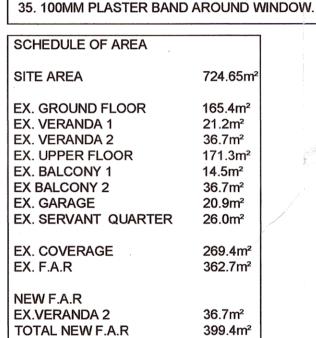

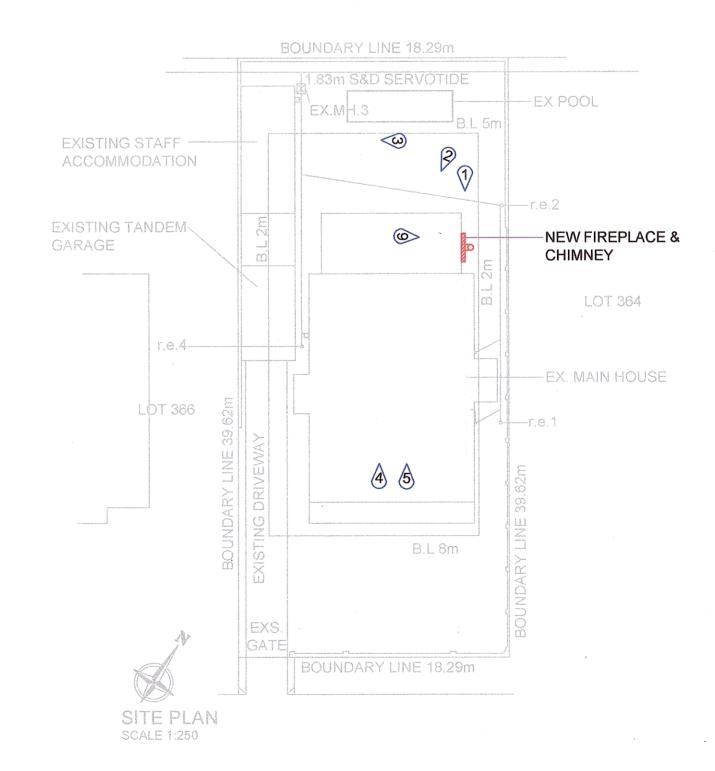

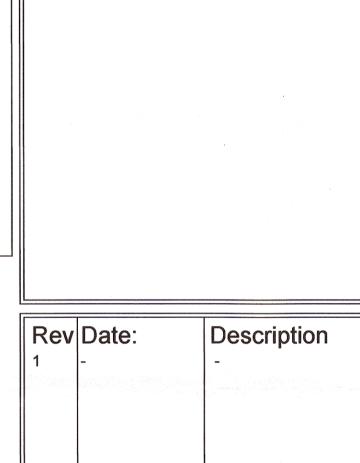

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No dimensions to be scaled from this


All dimensions to be checked on site by the

Where discrepancy occur the Contract

Administrator must be notified immediately

drawing

STAMP BLOCK:

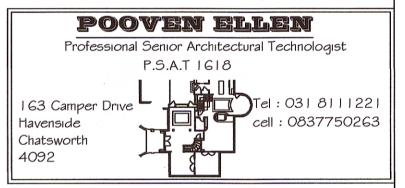

Architect name:	Signatures:
Pooven Ellen	(lee


Owner name: Signatures:

1. Paulette Olivia
Litkie

Project Title:
Additions & Alterations
Previous Approved Plan:

SITE:
15 Morningside Road
Durban
LOT 45 OF BLOCK AB

Drawing Titles
Floor Plan, Site Plan
Area of Schedule, Photos
SCALE: As Shown
DRAWING NO: 114AAA
DATE: 16/02/2022
DRAWN: A.F REVISION:
CHECKED: D.W 0

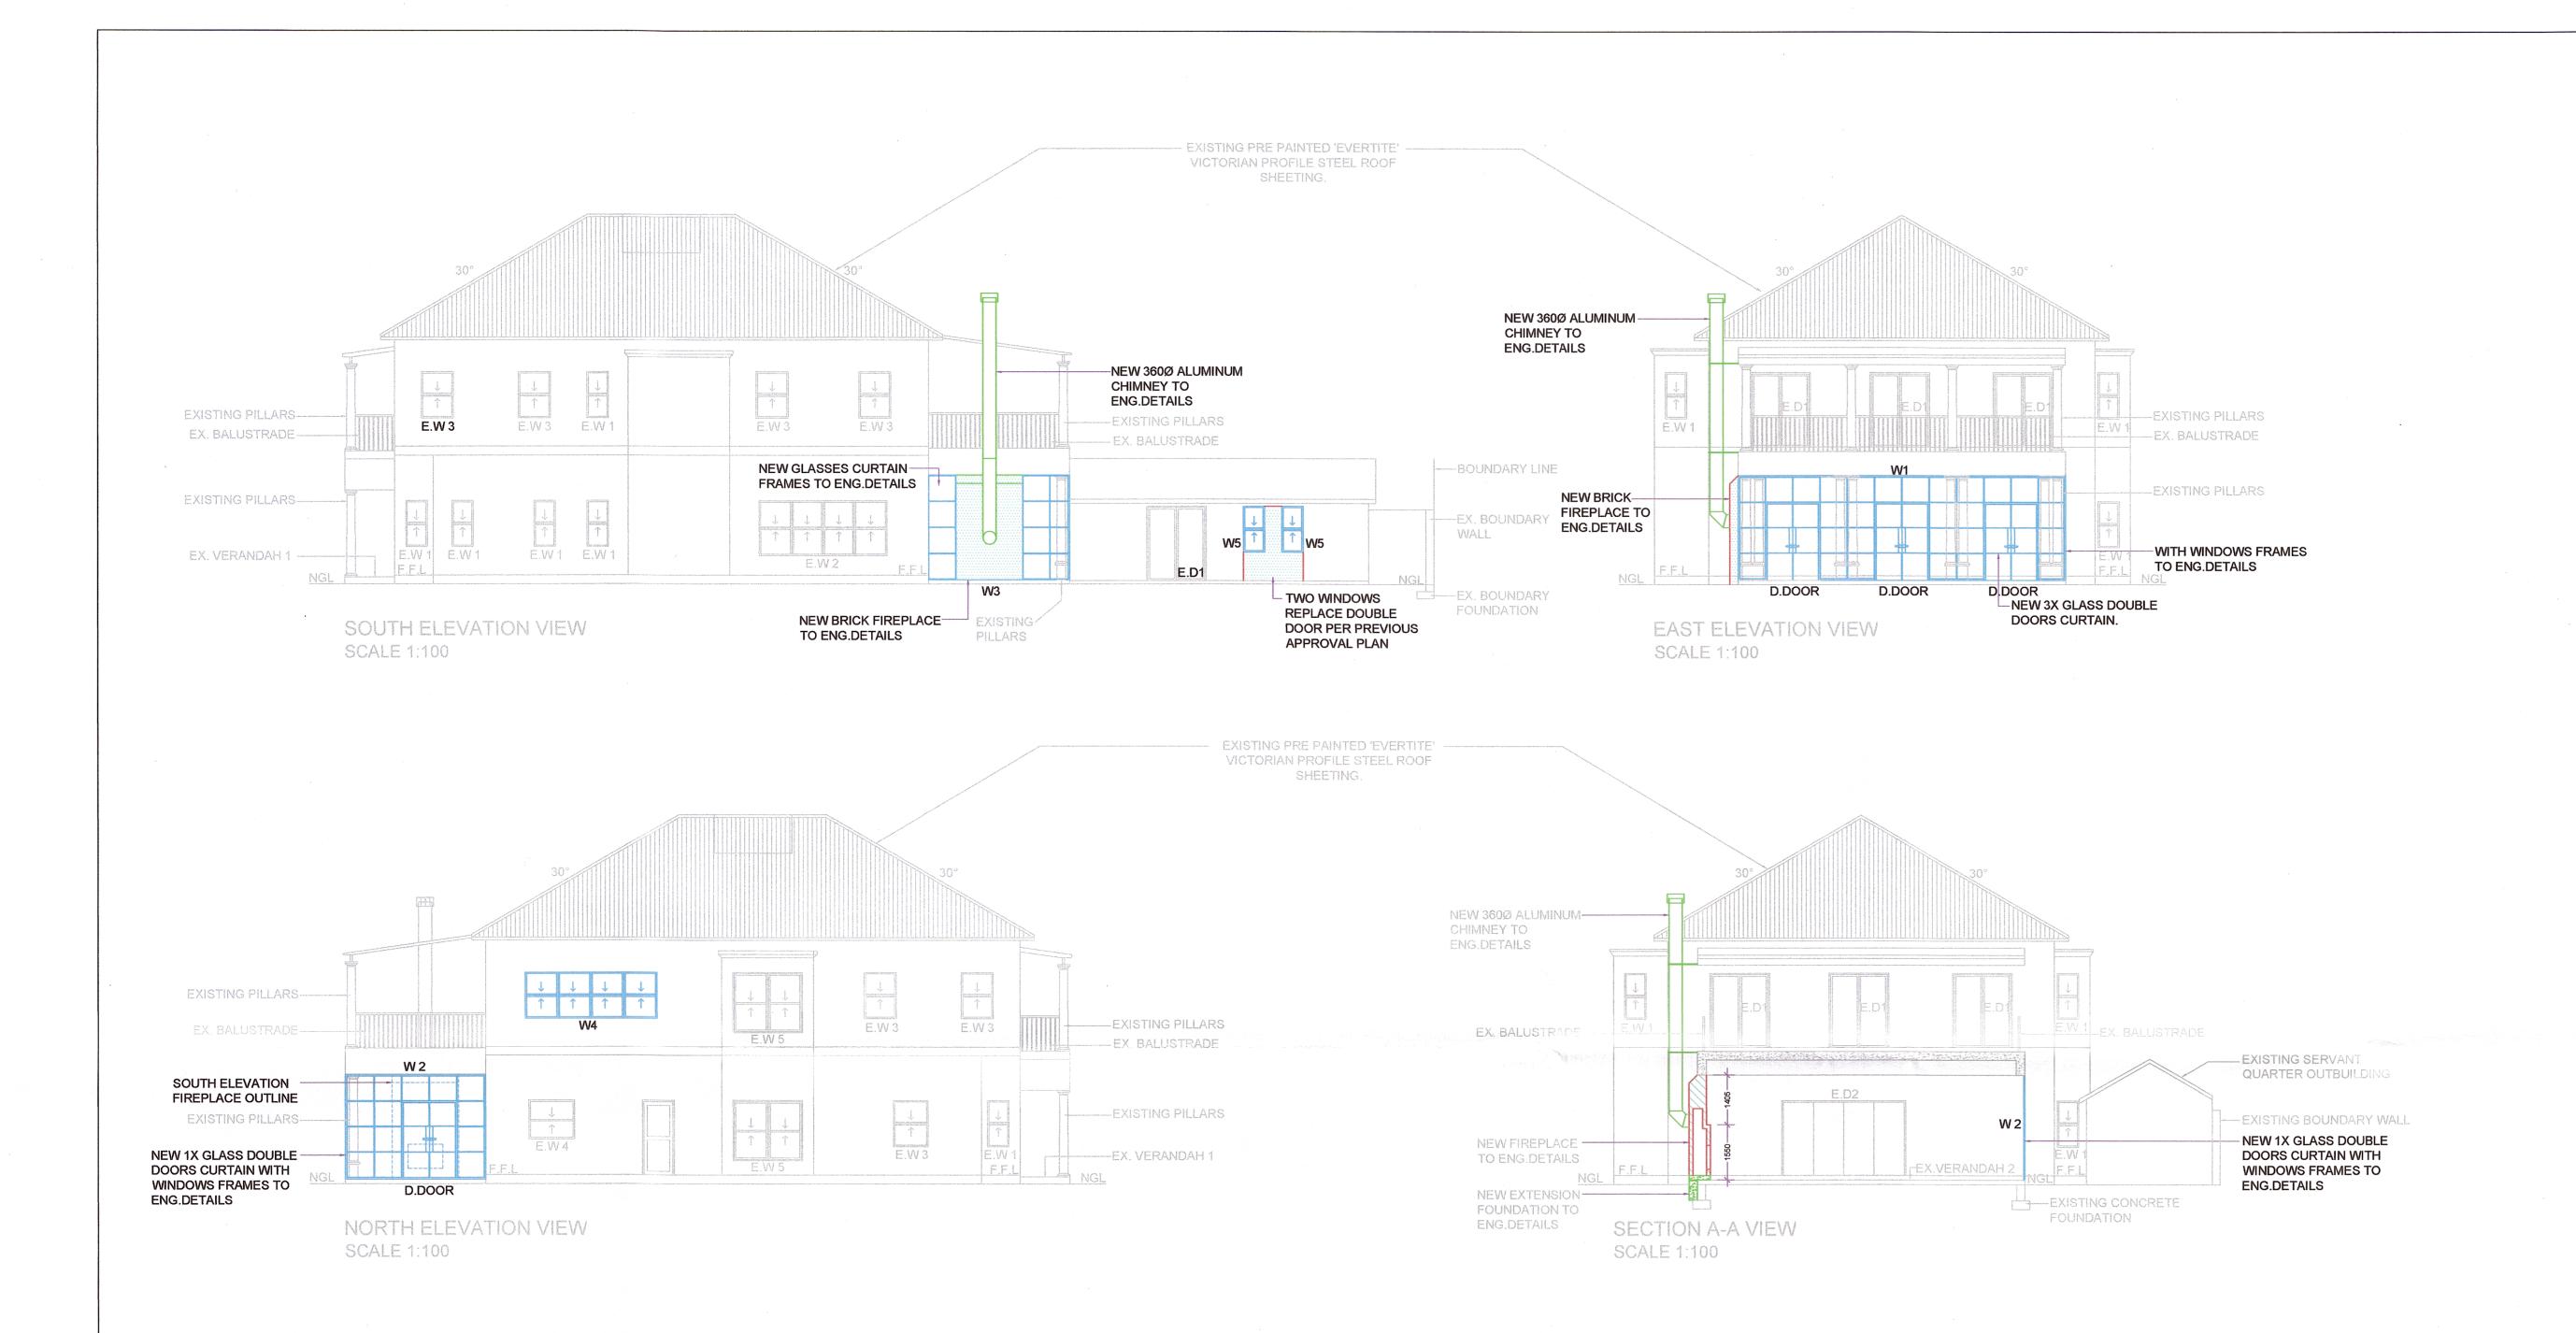

FENESTRATION CALCULATIONS: MAIN HOUSE

MAIN HOUSE GROUND	SOUTHE	ELEVATION	NORTH E	ELEVATION	EASTE	LEVATION	WEST EL	EVATION	TOTAL						
FLOOR + VERANDAH 2	window no.	window area.	window no.	window area.	window no.	window area.	window no.	window area.	FENESTRATION						
i e	E.W 1 x 5 E.W 2 x 1 W3	0.6 x 5 = 3.0 5.1 5.9 / 2 = 2.95	E.W 3 x 1 E.W 4 x 1 E.W 5 x 1	0.5 1.2 / 2 = 0.6	W1	27.3 / 2 = 13.65	l .	4.6 x 2 = 9.2 0.6 x 3 = 1.8	20.9%						
202.1m ²										FENESTRATION	ON CALCUI	_ATIONS : STA	EE ACCON	MODATION	
TOTAL		11.05		1.15		13.65		16.56	42.41m²	TENEOTION	J. C. LOOI	ZATIONO . OTA	11 70001	MINIODATION	
MAIN HOUSE	SOUTH ELEVATION		NORTH ELEVATION		EAST ELEVATION		WEST ELEVATION		TOTAL		SOUTH ELEVATION		EAST ELEVATION		TOTAL
PLAN	window no.	window area.	1	window area.	window no.	window area.	window no.	window area.	FENESTRATION		window no.	window area.	window no.	window area.	FENESTRATION
proposed net area	E.W 1 E.W 3 x 4	0.6 0.5 x 4 = 2.0	E.W 5 x 1	0.5 X 2 = 1.0 3.0 4.4	E.D1 x 3	1.65 x 3 = 4.95	E.D1 x 3	1.65 x 3 = 4.95	7.7%	proposed net area	E.D1 x 1 W5 x 2	1.65 0.6 x 2 = 1.2	E.W 1	0.6	9.9%
171.3m²										26.0m²					
TOTAL		2.6		8.4		4.95		4.95	25.85m ²	TOTAL		1.98		0.6	2.58m²

Notes:


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Contractor

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STAMP BLOCK:

Rev	Date:	Description
1		
		and the state of t



Architect name:	Signatures:
Pooven Ellen	Joen /

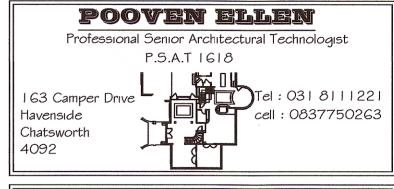Owner name:	Signatures:
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Litkie	Hull

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Durban
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Elevations,	Elevations,						
Section A-A	Section A-A						
SCALE: As Shown							
DRAWING NO: 114AAA							
DATE: 16/02/2022							
DRAWN: A.F REVISION:							
CHECKED:	D.W	0					