


Existing New Safely remove ex. asbestos sheeting extension of over. Replace with "Nutec Bigsix" FC awning corrugated sheeting. Extend awning over walkway and D02 as shown on plan and elevation. Finish: Terracotta Remove ex. timber beam fill, roof paint to match ex. roof tile color. To replace with brick / conc. beam fill manuf. spec. Keep ex. gutter. to suit. Plaster and paint to match. Clay tiles Clay tiles Remove ex. timber cleat Replace Win. Dims to match W01. and replace with Remove and replace 2NO. panels wide. galv.steel joist hangers ex. bay window - to to suit. match existing. See Demolish ex. stoep, window schedule. New window. Dims stairs and planter. Set to match **W**04 aside facebrick and Plaster & paint clay tiles for re-use. VERANDA . Demolish ex. stairs and AAV make good ex. wall to Plaster & paint (**W**03) **FFL:** 10 000 JFFL: 10 000 Facebrick match existing. 0000 0000 0000 000 Facebrick ex. AAV J FFL: 9315 J FFL: 9315 WT Replace ex. SVP with new 100mmØ uPVC AAV Move ex. door and New 50mmØ UG fanlight (D03) and **NORTH-WEST ELEVATION SOUTH-WEST ELEVATION PVC** waste water ex. gate (**G**03) to pipe, connect to 1:100 @ A1 Laundry 1:100 @ A1 ex. sewer line.

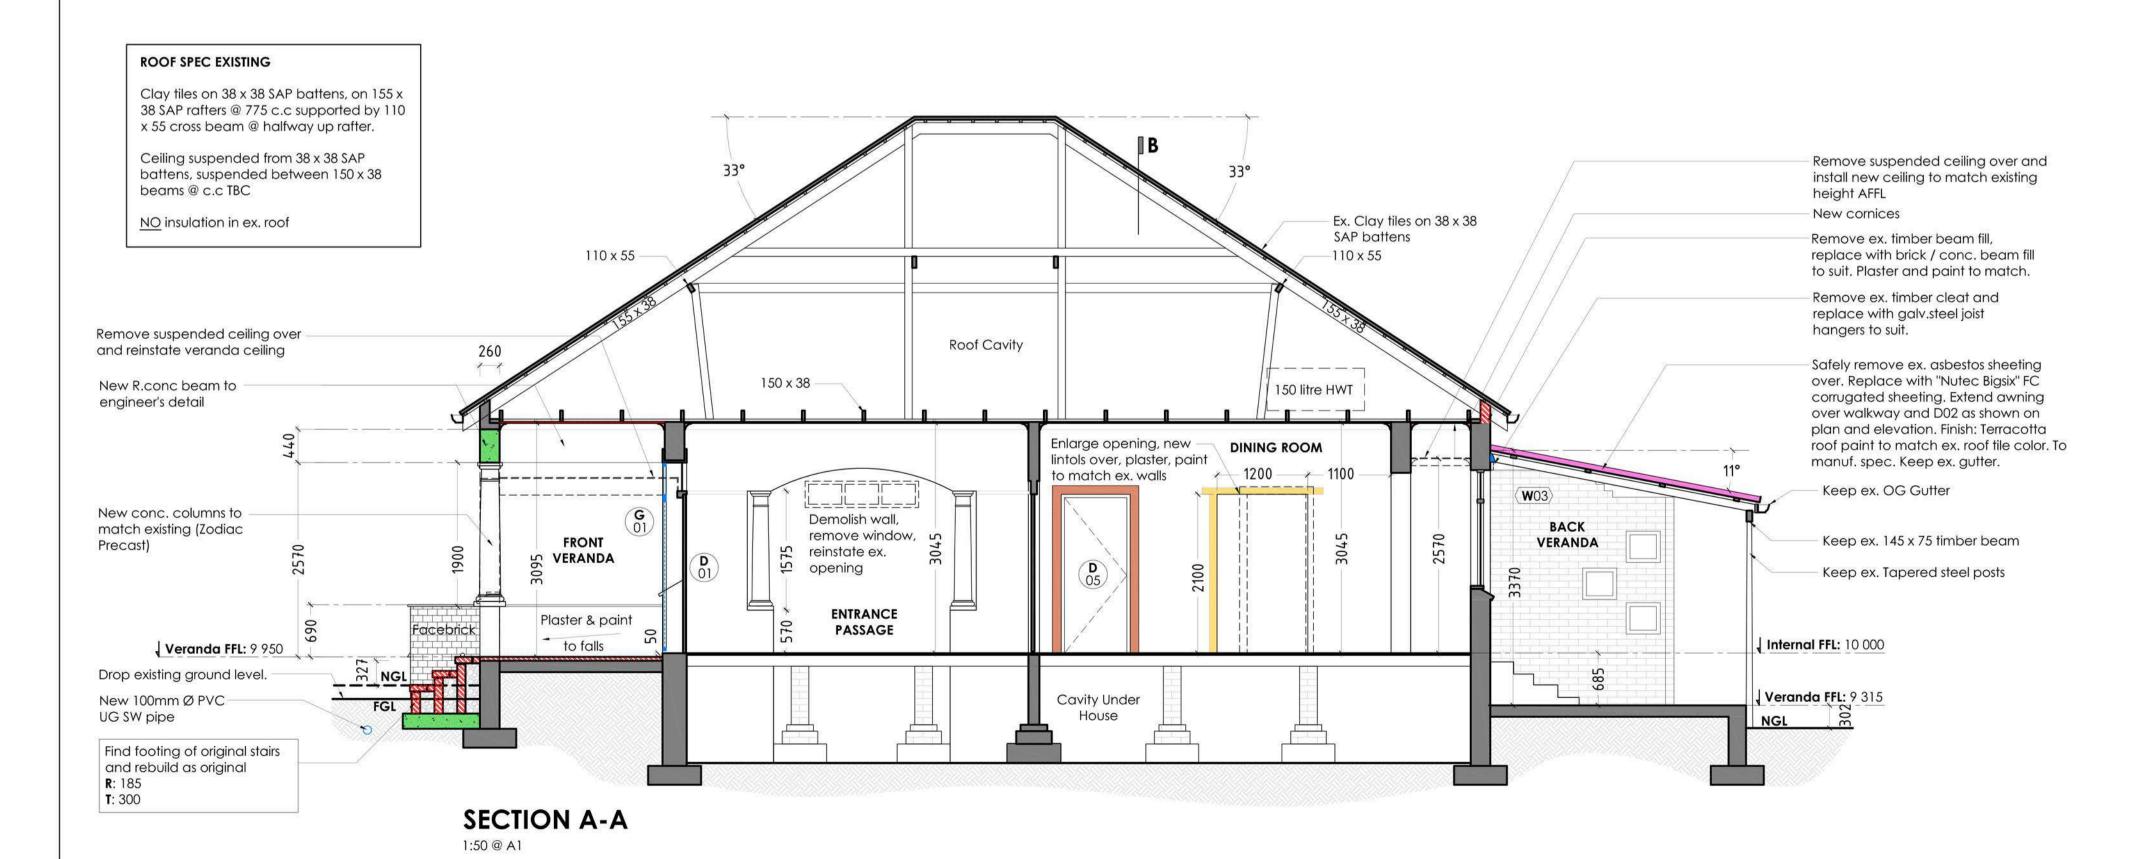

GENERAL CONSTRUCTION NOTES & SPECIFICATIONS

These apply to Main House and Outbuilding

SEWER

All existing clay/metal sewer pipes to be replaced with 100mmØ uPVC pipes. This includes outbuilding toilet. All to drain to ex. MHs.

WASTE WATER

All existing clay/metal waste water pipes to be replaced with 50mmØ uPVC pipes. All to drain to ex. gullys.

STORM WATER

All existing clay/metal SW pipes to be replaced with 100mmØ uPVC pipes. To drain to new soak-away.

WALLS

Assess and fill wall plaster cracks where visible. Fill bkwk mortar where needed. See finishes.

VERANDAS (BACK AND FRONT)

New floor finish: New terracotta tiles on existing screed surface (allowance: 15mm tile adhesive, 15mm tiles). Tiles to client's spec.

ROOF

MAIN HOUSE: Replace all existing roof members (trusses, props, rafters, battens etc) with new CCA treated SAP. To be approved by Engineer.

BACK VERANDA & OUTBUILDING: Safely remove ex. asbestos sheeting and replace with "Nutec Bigsix" FC corrugated sheeting. Finish: Terracotta roof paint to match ex. roof tile color. To manuf. spec.

INSULATION

IN MAIN HOUSE ROOF ONLY: Install 75mm blanket wool insulation with min. 1.88 R-Value (Pink Aerolite or equivalent)

CEILINGS, COVER STRIPS & CORNICES

All ex. ceilings to be replaced with 6mm "Nutec" ceiling board, finished with white water based acrylic to manuf. spec. Replace all ex. cornices and cover strips with Cedar Deodar timber - dimensions to match existing. Finish: Varnish Spec 1.

SKIRTING, DOOR FRAMES, DADO RAILS

Remove paint off all ex. timber skirting, door frames and dado rails. Replace / repair timber where required with Cedar Deodar timber - dimensions to match existing.

KITCHEN

Uplift ex. tiles and make good original floor (timber).

FINISHES


Paint External: Plascon "Wall and All" or equivalent. Colour to match existing, to clients approval.

Paint Internal: Plascon "Cashmere" or equivalent. Colour to match existing, to clients approval.

Paint Kitchen / Bathroom / En Suite: Plascon "Kitchens & Bathrooms" or equivalent. Colour to match existing, to clients approval.

Varnish Spec 1: "Woodoc 10 - Indoor Velvet Polywax Sealer" to manuf. spec. Gloss / semi-gloss / matt finish to be indicated by Client (this product can achieve all 3 finishes, see manufacturer's instruction).

Varnish Spec 2: "Woodoc 35 - Exterior Polywax Sealer" to manuf. spec. Colour: to Client's spec. (Meranti / Dark Brown / Russet)

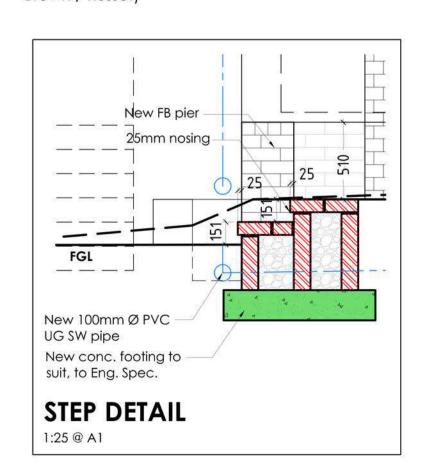

AMAFA SUBMISSION **DRAWINGS**

Neighbour's Address: Date: Name: Signed: Neighbour's Address Date: Name: Signed: Neighbour's Address: Date: Name: Signed: Neighbour's Address Date: Name: Signed: Neighbour's Address Date: Name: Signed:

HOUSE SINGH

15 Bedford Gardens

ELEVATIONS & SECTION A-A MAIN HOUSE

Client: Shanan Singh Address: 15 Bedford Gardens, 4001, Durban Cadastral: Lot 5551

Project:

ADDITIONS AND ALTERATIONS TO **EXISTING HERITAGE HOUSE**


Client's Signature

Architect's Signature

REGISTRATION No. 5027 54 EDMONDS ROAD, GLENWOOD, DURBAN, 4001. TEL: (031) 205 1410 e-mail: amanda@leadarchitects.co.za www.leadarchitects.co.za

Project Number: 1912 Date: 09 December 2019 Drawn: DV Dobrev Checked: AK Lead Scale: As shown @ A1

DWG No: 1912 41_02

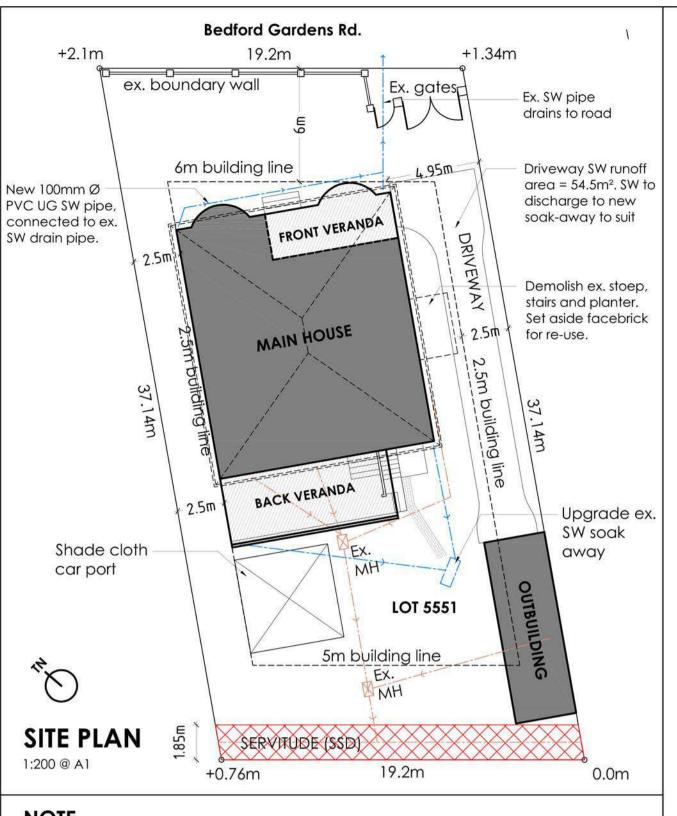

NOTE

All (hidden) services indicated (Sewer, SW) are based on latest approved plans dated 08.12.2000 by N.Chadderton. Exact positions to be confirmed on site.

TOWN PLANNING INFORMATION

Zoning: Special Residential 650 FAR: N/A

Coverage: 40%

Min Building Line: 6.0m to all road frontages; Swimming pool, 1.0m; Abutting N2, 15m; Abutting M19, 7.5m

Min Side S: Aggregate of 5.0m - one side not less than 2.0m; Multiple Unit: 3.0m on each side: where semi-detached 3.0m on other side. S/Pool, 1.0m. Non-res. 5.0m (see cl. 19(4)(a))

Min Rear S: 5.0m. Swimming Pool, 1.0m

Max Height: Double storey

Parking: Dependent on land use. See cl 12

No. Units: One dwelling unit for every 650sqm of net site area with the resultant quotient being taken to the nearest unit or if there is a fraction of one half, the next highest.

SITE INFORMATION

Site Area: Ex. Main House FAR: Ex. Main House COV: Ex. Outbuilding FAR: Ex. Outbuilding COV: **Ex. TOTAL FAR:** Ex. TOTAL COV:

702m² 155.6m² 187m² 12.6m² 31.4m² 168.2m² (0.24) 218.4m² (0.31)

- Reduce by 16.45m² - NO ADDITIONAL COVERAGE - NO ADDITIONAL FAR - NO ADDITIONAL COVERAGE - New FAR: 151.75m² (0.216)

New COV: 218.4m² (0.31)

RWT: rain water tank **SVP**: soil vent pipe SP: stand pipe **SH**: shower whb: wash hand basin **WC**: water closet (toilet pan) 100mm sewer 50mm waste water SW pipe New 100mm Ø PVC UG SW pipe, connected to ex. SW drain pipe. **GROUND FLOOR PLAN** MAIN HOUSE 1:50 @ A1 STORM WATER NOTE Total ex roof area **AFFL:** Above finished floor level

Ex. vehicular

Paving

Ex. SW

sump [

345

1013

+150

to falls

1013

New steps up

gate

Ex brick pier

Ex brick pier

Ex. brick piers

Ex. SW pipe drains to road gate

New FB piers. See

elevation for Height

3No. Weep holes @ FFL

wall, new brick parapet

veranda and bay

New bay, to match

existing

R: 185

T: 300

Reinstate original covered

New 100mm Ø PVC UG SW pipe,

connected to ex. SW drain pipe.

Remove ex. windows, demolish

New conc. columns to match-

Find footing of original stairs

Remove suspended ceiling

over and reinstate veranda

Remove ex. windows,

demolish wall

AAV: air admittance valve

rwdp: rain water down pipe

PLUMBING KEY

ie: inspection eye

MH: man hole

SW: storm water

existing (Zodiac Precast)

and rebuild as original

H: 1850

H: 1850

(main house, verandas, outbuilding) discharging to soak $pit = 147.1m^2$ Total ex roof area (main house)

discharging to road

 $(ex. pipe) = 86.4m^2$

 Total new paved area (driveway) = 54.5m² Existing soak-away is

currently dealing

effectively with

existing SW volumes. No additional coverage. Only new driveway paving

Calculation: 54.5m² / 40 = 0.73 cubic metres additional required. ie. 1m (L) x chamber in addition to existing.

260

New SW

sump

1. Drawings to be read in conjunction with surveyor's drawings and engineer's drawings. 2. The contractor shall be

setting out of the building and its internal and external

foundations, retaining walls, walls, lintols, beams, roof be designed by engineer and/or to comply with immediately brought to the detailed requirements of Parts attention of the Architect. B, H, J, K, L, M & N of SANS

9.8m²

Ablution

1.55m²

0m² (0%)

2.2m² (142%)

3.78m² (19.2%) | 2.36m² (24%)

1.32m² (13.5%)

10400. 4. Drawings are not to be 2. All foundations to comply with SANS 10400 Part H.

specialist.

Ex. planter

New win.

New shelving

to clients spec

STUDY

Screed

F2C: 3045

FFL: 10 000

Enlarge opening,

New dado rail /

repair ex. dado

PASSAGE

10 F2C: 3045

145 11

D Timber + 700 ∤

rail to match

existing

STORAGE

Expand ex. ceiling trapdoor.

= max allowable. No cover

strips on ceiling in PASSAGE

BEDROOM

Timber

F2C: 3045

FFL: 10 000

(W06)

Win H: 1630

3350

13363

3. Ant soil poison to be

applied and certified by

4. All masonry walls to comply

5. All beams and lintols to be

designed / specified by

with Parts B & K of SANS 10400

Cill H AFFL: 760

Width = ex. rafter gap, Length

new lintols over,

plaster, paint.

455 + 600 + 455 +

4550

New conc. columns to match

FFL: 8 905

Win H: 1630

LIVING ROOM

Timber

F2C: 3045

FFL: 10 000

New dado rail / repair ex.

reinstate ex. opening

Demolish wall,

dado rail to match existing

Ex. Arch over

ENTRANCE PASSAGE

Timber

F2C: 3045

FFL: 10 000

Cill H AFFL: 760

existing (Zodiac Precast)

New weather blind, to owner's

brick parapet Replace Win W11

spec. By Specialist.

Demolish wall, new

comply with Parts D & E of

engineer. 6. Roofing and ceiling assembly to comply with Parts B & L of SANS 10400 7. All stairs to comply with Part M of SANS 10400

2.48m² 4.1m²

Store Room (Non-Hab)

FINISHES 1. Generally all external

Kitchen / Laundry | Dining Room | Bathroom

18.74m²

1.71 (9.1%)

unless otherwise specified. 2. Generally all internal finishes plastered and painted to match existing, unless

Demolish ex. stoep, stairs and

Remove ex. win and door, brick

Replace ex. gully

Win H: 1055

Cill H AFFL: 1045

Repair / replace ex. vent

Drains to ex. MH

up opening, new window to

planter. Set aside facebrick

and clay tiles for re-use.

Demolish wall,

To eng. spec.

Extend counter

(hatch=new)

KITCHEN

Timber

F2C: 3045

FFL: 10 000

1200

5713

Make good existing

arch over (fill cracks).

DINING ROOM

Timber

F2C: 3045

FFL: 10 000

Repair / replace

Replace shower

door. To match

existing bi-fold.

BEDROOM 3

Timber

F2C: 3045

FFL: 10 000

Win H: 1630

Cill H AFFL: 760

Rem. ex. concerting

door, add new door

Refit and

wo5 ex. ehb

seal taps on

145

BATHROOM

Tiles

F2C: 3045

new lintols over.

match existing.

otherwise specified. 3. New facebrick walls to match existing, to Architect's approval.

4. Floor finishes as indicated on drawings and finishes schedule, by Specialist. 5. All internal timber to be treated against wood eating insects with approved product strictly to manuf.

6. Refer to finishes schedule

primed and painted with enamel to manufacturer's specifications.

GLAZING

868 🗼 260

 New windows and glazing elements to comply with Part N of SANS 10400. Refer to window and door schedule and SANS 10400:XA report attached.

2. New 6mm toughened safety fixed glass shower panel by specialist to comply with Part N 4.4.6 of SANS 10400

Master Bedroom | Bedroom 2 | Bedroom 3 | En Suite

9.5m²

1.26 (8.8%) | 1.26 (13.3%) | 0.4 (16.13%)

14.2m²

2.48m²

Neighbour's Address:

AMAFA SUBMISSION

DRAWINGS

Name: Signed:

Signed: Neighbour's Address

Neighbour's Address

Date:

Date:

Name:

Signed:

Name:

Signed:

Name:

Neighbour's Address

Neighbour's Address over walkway and

Date: Name: Signed:

HOUSE SINGH

15 Bedford Gardens

GROUND FLOOR PLANS MAIN HOUSE & OUTBUILDING

Client: Shanan Singh Address: 15 Bedford Gardens, 4001, Durban Cadastral: Lot 5551

Project:

ADDITIONS AND ALTERATIONS TO EXISTING HERITAGE HOUSE

Client's Signature

Architect's Signature

REGISTRATION No. 5027 54 EDMONDS ROAD, GLENWOOD, DURBAN, 4001. TEL: (031) 205 1410 e-mail: amanda@leadarchitects.co.za www.leadarchitects.co.za

Project Number: 1912 Date: 01 December 2019 Drawn: DV Dobrev Checked: AK Lead Scale: As shown @ A1

DWG No:

1912 41_01

REV

	Te.		
Bedford Ga	dens	TANK I	
Ma		E	
	元 記 2		
1			1/3
	o to America Trick (Total		Goog
		Reditate Strictors	

LOCALITY PLAN Google Earth

Not to scale @ A1 New masonry New concrete New plaster & paint New iron or steel All existing New fibre cement New PVC Colour Key WT: Wash Trough

F2C: Finished floor level to underside of ceiling FAR: Floor Area Ratio FB: Facebrick FC: Fibre Cement

T: Tread

UG: Underground

WC: Water closet (toilet pan)

Whb: Wash-hand basin

WM: Washing Machine

US: Underside

Win: Window

FFL: Finished floor level FGL: Finished Ground Level FR: Refrigerator H: Height

LIST OF ABBREVIATIONS

Conc: Concrete

COV: Coverage

Ex: Existing

HWT: Hot Water Tank **NGL**: Natural Ground Level MH: Manhole **Qry**: Quarry R: Riser

SAP: South African Pine SH: Shower **SOP**: Setting out point SW: Storm water applies. TO: Top of

 $0.9m (W) \times 0.9m (H)$

PART O CALCULATIONS

MAIN HOUSE

Room Area:

OUTBUILDING

Room Area:

ighting (L) Area:

Ventilation (V) Area:

ighting (L) Area:

Ventilation (V) Area:

New step

Win H: 1570

Cill H AFFL: 750

GENERAL NOTES scaled. Prefer written dimension.

responsible for the correct

Living Room

3.96m² (20%)

19.65m²

Garage

15.98m²

0m² (0%)

5.8m² (36.3%)

Small bump

New low wall

Win H: 1630

FRONT VERANDA

FFL: 9 950

Remove beam and

Remove and replace

ex. bay window - to

match existing. See

Remove and replace ex.

See window schedule.

windows - to match existing.

window schedule.

dry wall over

Terracotta Tiles ≥

Cill H AFFL: 760

+50

MASTER BEDROOM

Timber

F2C: 3045

FFL: 10 000

Win H: 950

Cill H AFFL: 1150

08

W07

Win H: 1630

Cill H AFFL: 760

145

Paving

to falls

Ex. rwdp

walling and is to check all levels, heights, and dimensions generally and build in DPC's whether shown or not, to all walls, beams, parapets, doors, windows and other external openings, as per SANS 10400 / SABS 021 3. Any discrepancies to be

SITE 1. All demolition work to

SANS 10400 2. All site work to comply with Parts F & G of SANS 10400

STRUCTURAL All structural components structure, slabs and stairs - to

Ent. Passage | Passage | Study

N/A

N/A

9.4m²

0.65m² (6.9%)

1.57m² (11%)

finishes to match existing,

11.08m²

0.65m² (15.6%) 2.33m² (21%)

0.61m² (14.9%) 4.36m² (39.4%)

4.5m²

0.4m² (8.8%)

spec.

22.41m²

4.94m² (22%)

4.15 (22.1%) | 0.55m² (12.2%) | 4.32m² (19.3%) | 1.18 (8.3%) | 1.18 (12.4%) | 0.55 (22.18%)

for internal and external timber finishes. 7. All steel to be galvanized,

DRAINAGE 1. All new drainage by certified specialist, in strict accordance with Part P of

SANS 10400 2. Hot water supply to comply with 4.1 of Part XA of SANS 10400

10 615 725

Drains to SW soak-away

Replace Win. Dims to

match **W**01. 2NO.

Line of ex. awning over

+200

+150 × 2

3 0

panels wide.

T: 240

R: varies

T: varies

Move ex. gate to

(**G**07). Enlarge

Remove suspended

new ceiling to match

existing height AFFL

BACK VERANDA

FFL: 9 345

Win H: 500

AAV

New win

Win H: 500

Cill H AFFL: 1655

______=========

EN SUITE

Tiles on conc.

F2C: 3045

FFL: 10 000

3370

3688

Cill H AFFL: 1655

Terracotta Tiles

ceiling over and install

Drains to ex. MH

Demolish ex. stairs

Ex. rwdp

SANS 10400.

10400.

2. All new rainwater and

WATER RETICULATION

change in ex. water

reticulation.

PART XA

stormwater disposal goods to

comply with Part R of SANS

No additional sanware, no

1. Lighting and ventilation in

accordance with Part O of

△ Outbuilding Storeroom

opening to suit door

frame from En Suite.

Ex. Brick Path

Ex. planter

/ 1069

To Garage

2136

New 50mmØ UG

PVC waste water

pipe, connect to

ex. sewer line.

Extend awning

plan and

New weather

blinds, to owner's

spec. By Specialist.

Safely remove ex.

asbestos sheeting

over. Replace with

"Nutec Bigsix" FC

sheeting. Finish to

Arch. spec. Keep

Remove ex. files

and re-tile floor

Tiles to client's

Replace ex. SVP

UPVC AAV

with new 100mmØ

Move ex. door and

fanlight (**D**03) and

ex. gate (G03) to

Laundry, brick up

opening and add

new window

New weather blind,

to owner's spec. By

(centre)

Ex. SW sump

soak-pit

Specialist.

2 drains to ex SW

and walls, up to

existing level.

spec.

corrugated

ex. gutter.

Refit bath

overflow outlet

D02 as shown on

Edge of new SW

OUTBUILDING PLAN

channel, see

Ex. Boundary wall

to falls

LAUNDRY

Tiles on conc.

F2C: 3045

FFL: 10 000

Ex. rwdp

new ie

