


01 GROUND STOREY SKETCH PLAN

SCALE: 1:100



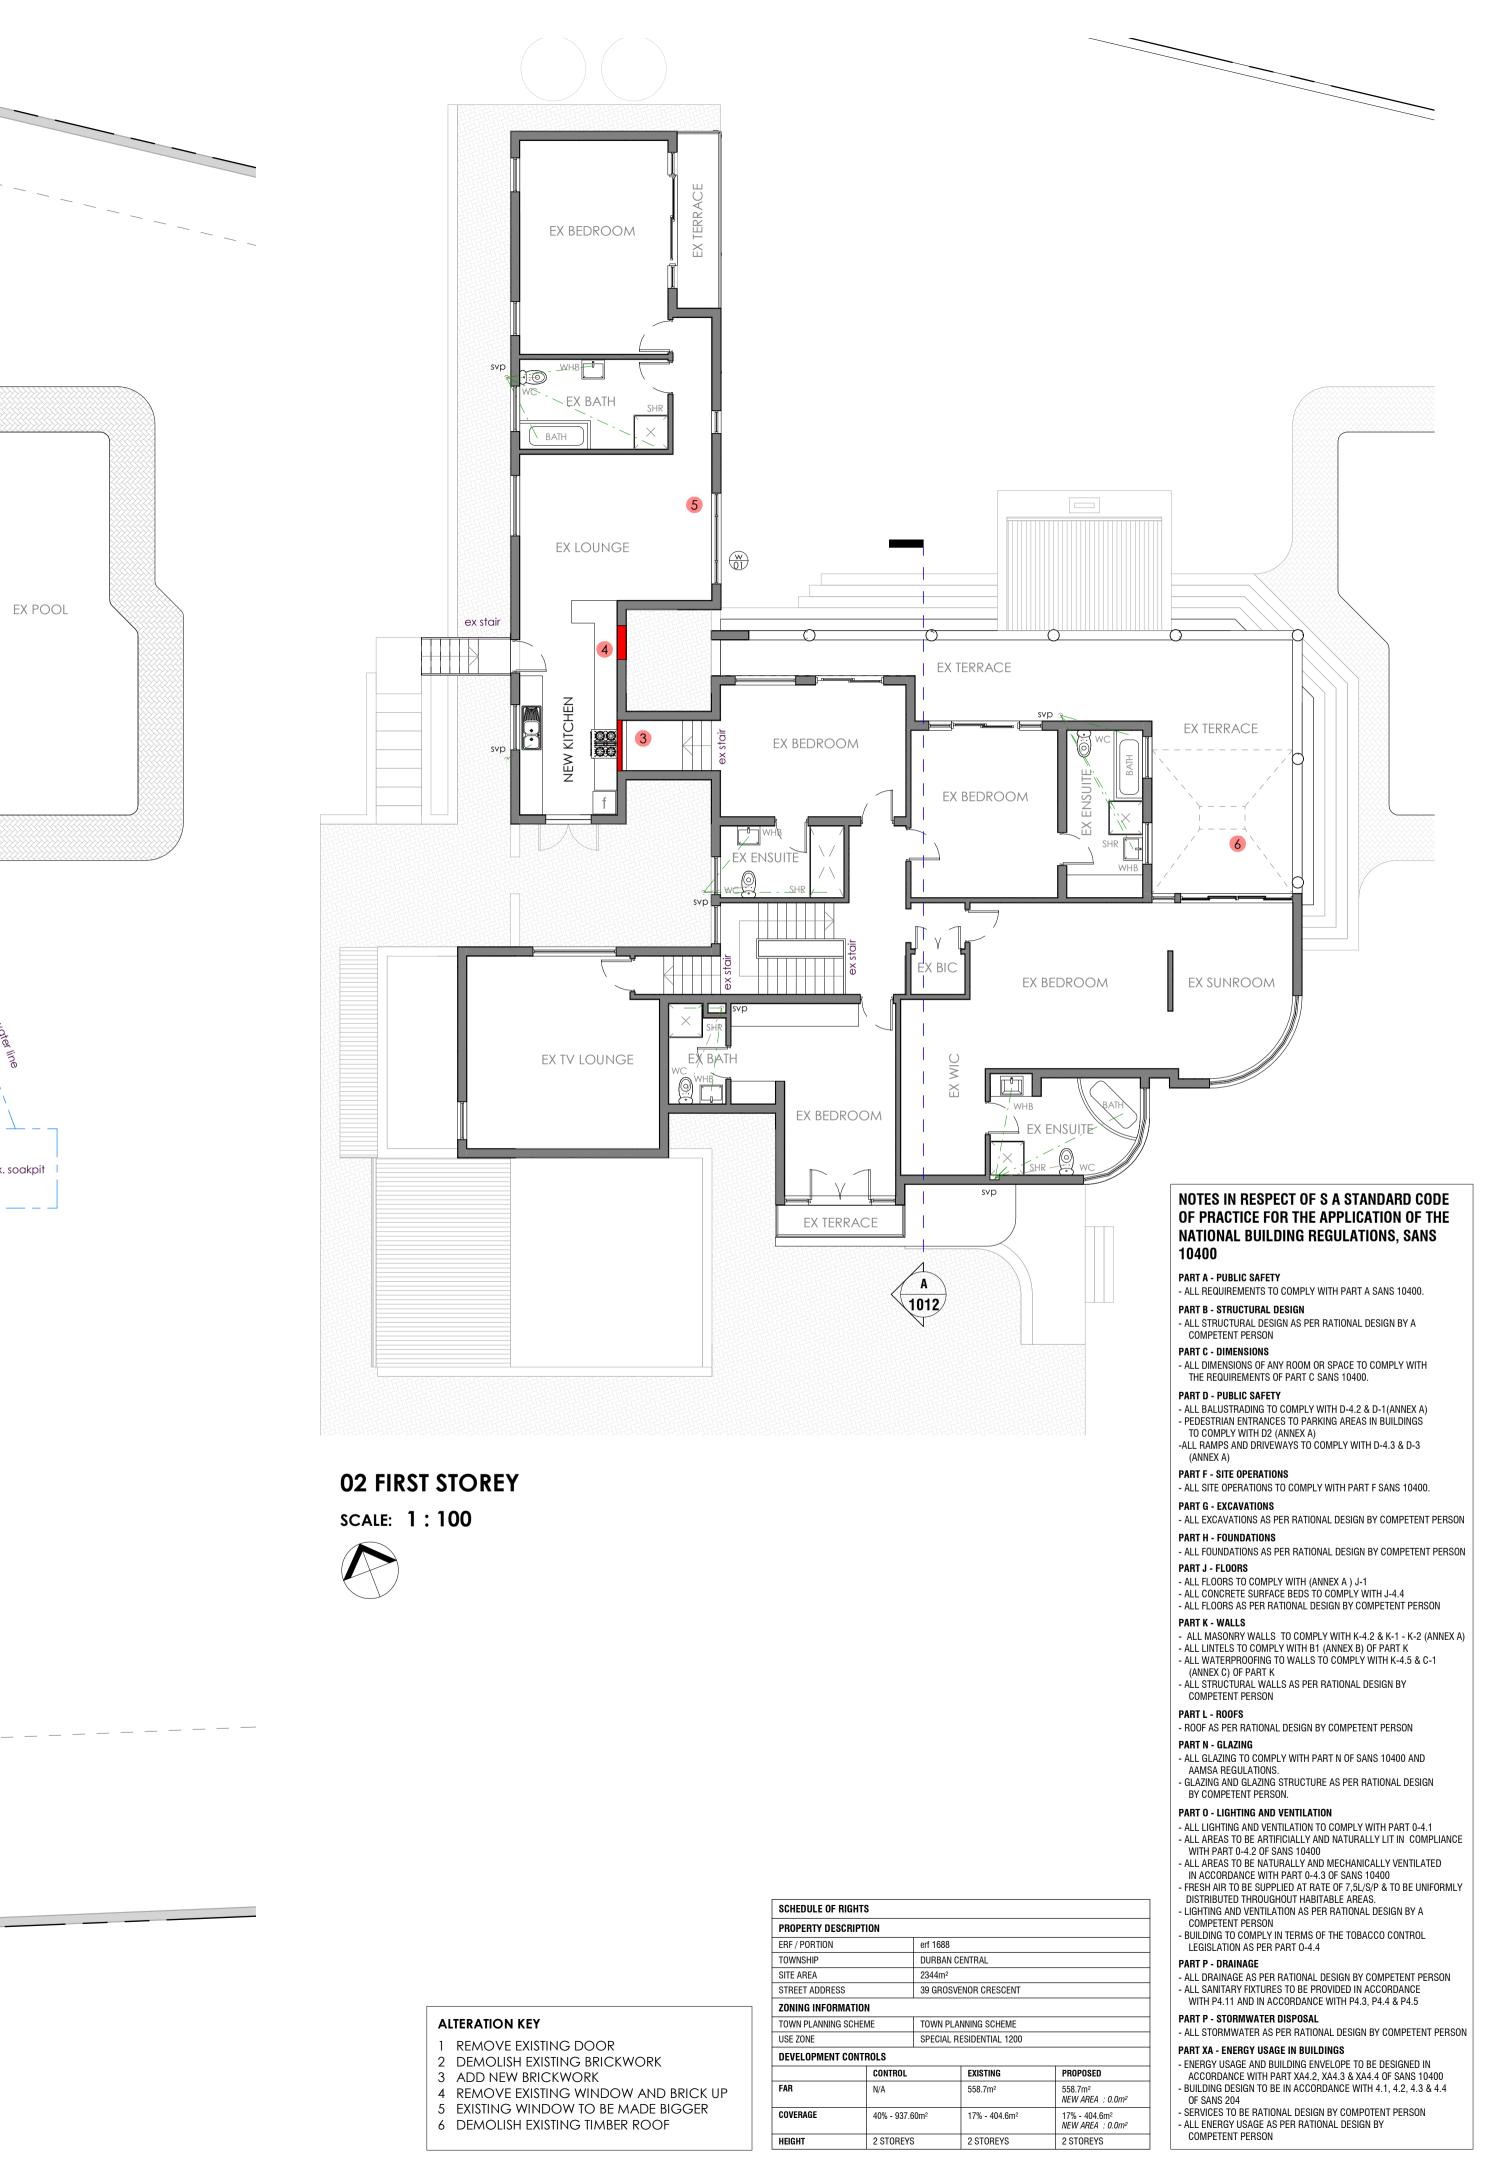

SCHEDULE OF R	IGHIS			
PROPERTY DESC	RIPTION			
ERF / PORTION		erf 1688		
TOWNSHIP		DURBAN CENTRAL		
SITE AREA		2344m ²		
STREET ADDRESS		39 GROSVENOR CRESCENT		
ZONING INFORM	ATION			
TOWN PLANNING SCHEME		TOWN PLANNING SCHEME		
USE ZONE		SPECIAL RESIDENTIAL 1200		
DEVELOPMENT (CONTROLS			
	CONTROL		EXISTING	PROPOSED
FAR	N/A		558.7m ²	558.7m ² NEW AREA : 0.0m ²
COVERAGE	40% - 937.6	60m²	17% - 404.6m ²	17% - 404.6m ² NEW AREA : 0.0m ²
HEIGHT	2 STOREYS	6	2 STOREYS	2 STOREYS

CLIENT SIGNATURE

ENGINEER SIGNATURE

ARCHITECT SIGNATURE

LANCE MACBEAN PSAT 24750799



Lance MacBean 083 356 2422 lance@planningsolutions.co.za

www.planningsolutions.co.za

PROJECT Alterations to House Honeywell

LOCATION

erf 1688 Durban North, 39 Grosvenor Crescent, Durban North

CLIENT Mike Honeywell

PROJECT NO. PROJECT NO. CAT. DRAWING NO. 20037 - SK - 1011 DRAWING Submission Drawing

> DRAWN LMB

indicated DATE 14/08/2023

11:18:34


SCALE

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A1

CHECKED LMB

SHEET SIZE REVISION 0

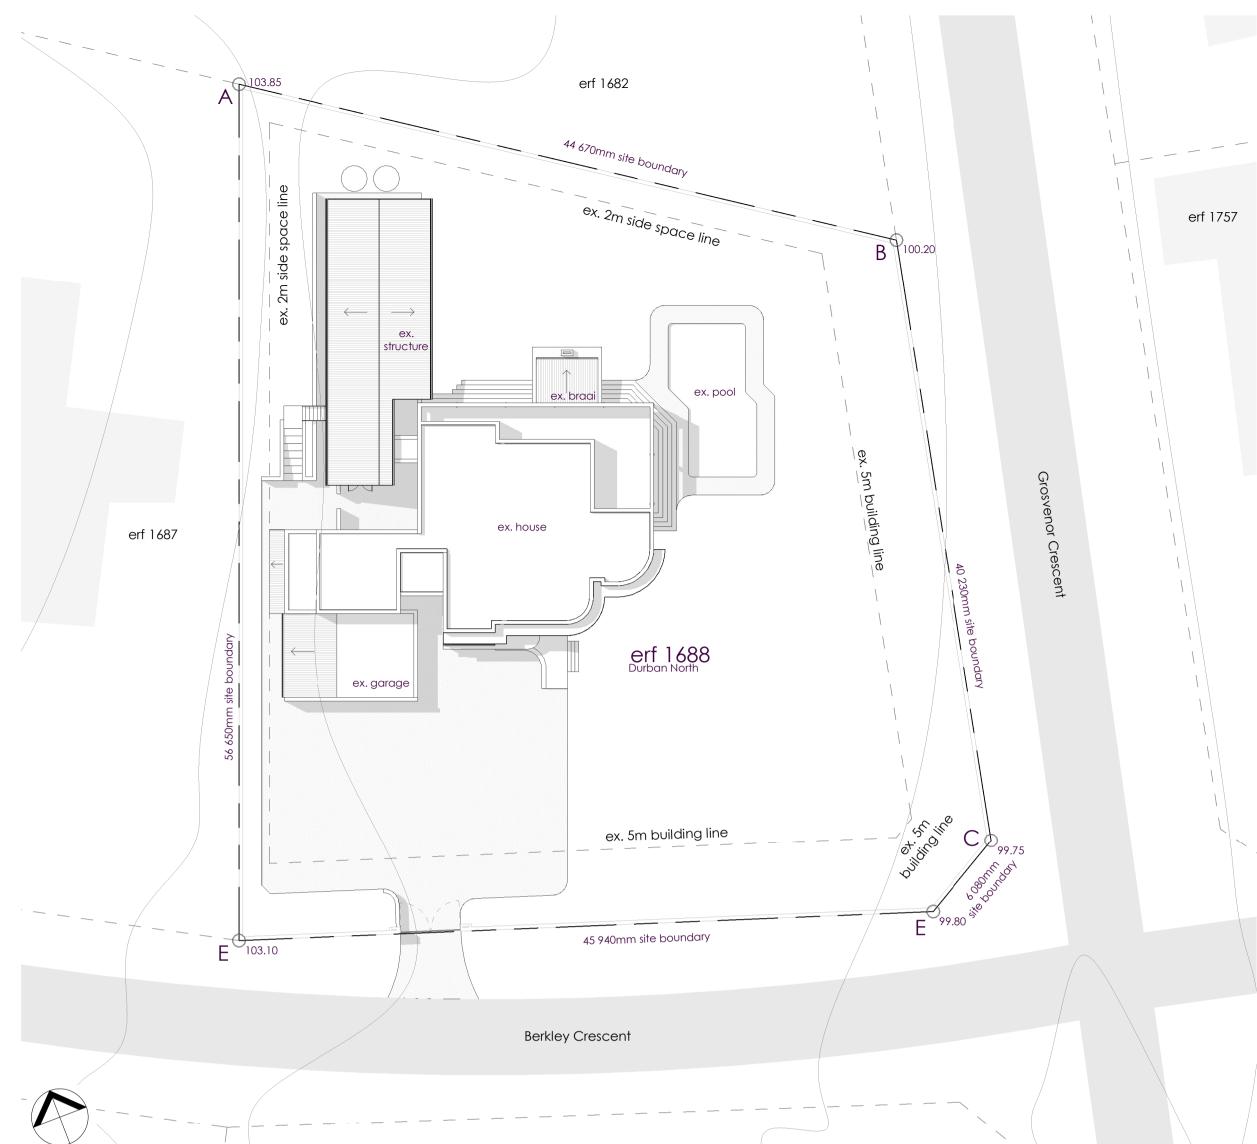

03 SITE PLAN

scale: **1 : 250**

NOTES IN RESPECT OF S A STANDARD CODE OF PRACTICE FOR THE APPLICATION OF THE NATIONAL BUILDING REGULATIONS, SANS

10400

- PART A PUBLIC SAFETY
- ALL REQUIREMENTS TO COMPLY WITH PART A SANS 10400.
- PART B STRUCTURAL DESIGN - ALL STRUCTURAL DESIGN AS PER RATIONAL DESIGN BY A
- COMPETENT PERSON PART C - DIMENSIONS - ALL DIMENSIONS OF ANY ROOM OR SPACE TO COMPLY WITH
- THE REQUIREMENTS OF PART C SANS 10400. PART D - PUBLIC SAFETY
- ALL BALUSTRADING TO COMPLY WITH D-4.2 & D-1 (ANNEX A) - PEDESTRIAN ENTRANCES TO PARKING AREAS IN BUILDINGS
- TO COMPLY WITH D2 (ANNEX A) -ALL RAMPS AND DRIVEWAYS TO COMPLY WITH D-4.3 & D-3

(ANNEX A)

PART F - SITE OPERATIONS - ALL SITE OPERATIONS TO COMPLY WITH PART F SANS 10400.

PART G - EXCAVATIONS

- ALL EXCAVATIONS AS PER RATIONAL DESIGN BY COMPETENT PERSON
- PART H FOUNDATIONS - ALL FOUNDATIONS AS PER RATIONAL DESIGN BY COMPETENT PERSON
- PART J FLOORS
- ALL FLOORS TO COMPLY WITH (ANNEX A) J-1 - ALL CONCRETE SURFACE BEDS TO COMPLY WITH J-4.4
- ALL FLOORS AS PER RATIONAL DESIGN BY COMPETENT PERSON PART K - WALLS
- ALL MASONRY WALLS TO COMPLY WITH K-4.2 & K-1 K-2 (ANNEX A) - ALL LINTELS TO COMPLY WITH B1 (ANNEX B) OF PART K
- ALL WATERPROOFING TO WALLS TO COMPLY WITH K-4.5 & C-1 (ANNEX C) OF PART K - ALL STRUCTURAL WALLS AS PER RATIONAL DESIGN BY

COMPETENT PERSON

PART L - ROOFS

- ROOF AS PER RATIONAL DESIGN BY COMPETENT PERSON

- PART N GLAZING - ALL GLAZING TO COMPLY WITH PART N OF SANS 10400 AND AAMSA REGULATIONS.
- GLAZING AND GLAZING STRUCTURE AS PER RATIONAL DESIGN BY COMPETENT PERSON.

PART 0 - LIGHTING AND VENTILATION

- ALL LIGHTING AND VENTILATION TO COMPLY WITH PART 0-4.1 ALL AREAS TO BE ARTIFICIALLY AND NATURALLY LIT IN COMPLIANCE WITH PART 0-4.2 OF SANS 10400
- ALL AREAS TO BE NATURALLY AND MECHANICALLY VENTILATED IN ACCORDANCE WITH PART 0-4.3 OF SANS 10400
 FRESH AIR TO BE SUPPLIED AT RATE OF 7,5L/S/P & TO BE UNIFORMLY DISTRIBUTED THROUGHOUT HABITABLE AREAS.
- LIGHTING AND VENTILATION AS PER RATIONAL DESIGN BY A
- COMPETENT PERSON - BUILDING TO COMPLY IN TERMS OF THE TOBACCO CONTROL LEGISLATION AS PER PART 0-4.4

PART P - DRAINAGE

- ALL DRAINAGE AS PER RATIONAL DESIGN BY COMPETENT PERSON - ALL SANITARY FIXTURES TO BE PROVIDED IN ACCORDANCE WITH P4.11 AND IN ACCORDANCE WITH P4.3, P4.4 & P4.5 PART P - STORMWATER DISPOSAL
- ALL STORMWATER AS PER RATIONAL DESIGN BY COMPETENT PERSON PART XA - ENERGY USAGE IN BUILDINGS
- ENERGY USAGE AND BUILDING ENVELOPE TO BE DESIGNED IN ACCORDANCE WITH PART XA4.2, XA4.3 & XA4.4 OF SANS 10400 - BUILDING DESIGN TO BE IN ACCORDANCE WITH 4.1, 4.2, 4.3 & 4.4 OF SANS 204
- SERVICES TO BE RATIONAL DESIGN BY COMPOTENT PERSON - ALL ENERGY USAGE AS PER RATIONAL DESIGN BY COMPETENT PERSON




Section AA

SCALE: 1:100

ALTERATION KEY


- 1 REMOVE EXISTING DOOR 2 DEMOLISH EXISTING BRICKWORK
- 3 ADD NEW BRICKWORK
- 4 REMOVE EXISTING WINDOW AND BRICK UP
- 5 EXISTING WINDOW TO BE MADE BIGGER 6 DEMOLISH EXISTING TIMBER ROOF

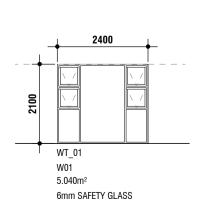

WINDOW SCHEDULE




South East Elevation SCALE: 1:100

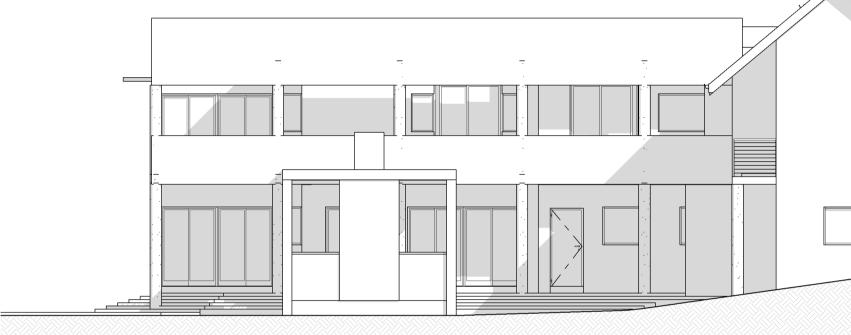


North East Elevation SCALE: 1:100

South West Elevation SCALE: 1:100

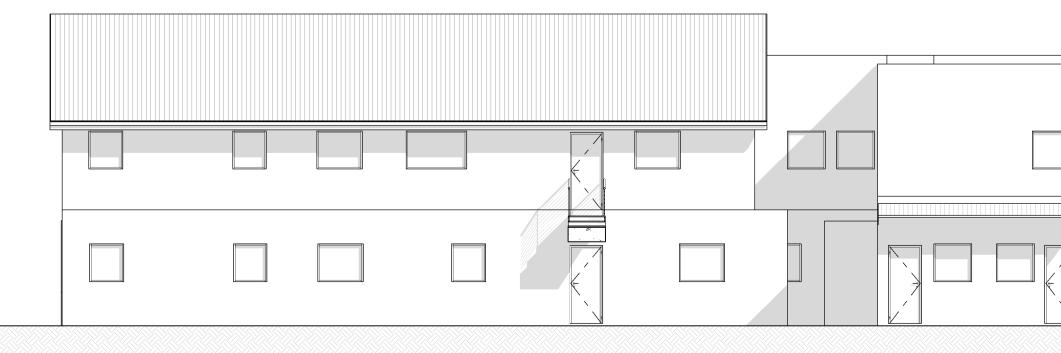

North West Elevation SCALE: 1:100

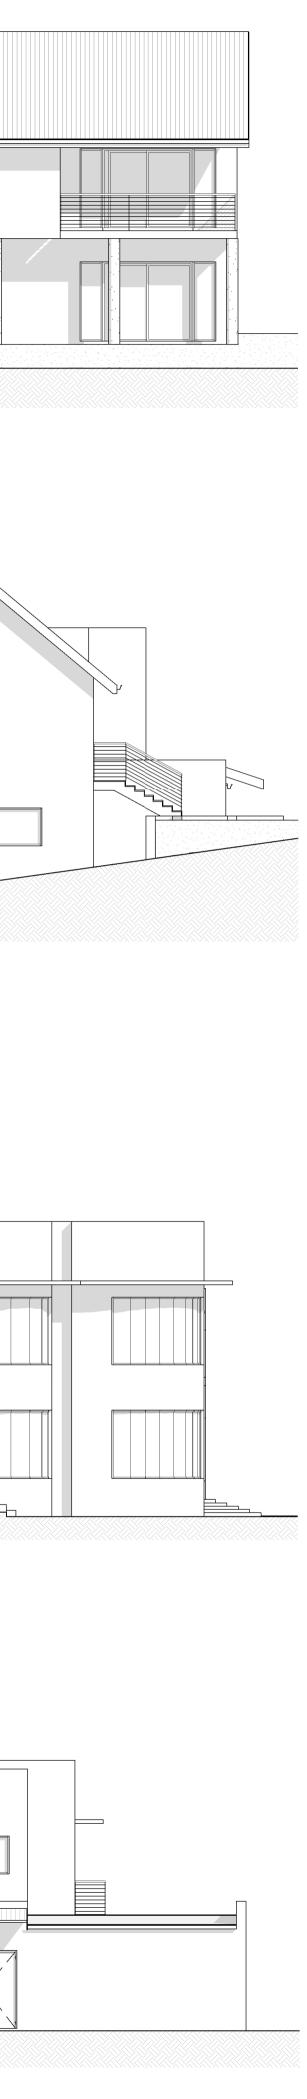

Whoneywell CLIENT SIGNATURE

ENGINEER SIGNATURE

ARCHITECT SIGNATURE

LAMBORIN LANCE MACBEAN PSAT 24750799



Lance MacBean 083 356 2422 lance@planningsolutions.co.za

www.planningsolutions.co.za

PROJECT Alterations to House Honeywell

LOCATION erf 1688 Durban North, 39 Grosvenor Crescent, Durban North

CLIENT Mike Honeywell

PROJECT NO. PROJECT NO. CAT. DRAWING NO. 20037 - SK - 1012

DRAWING Submission Drawing

SCALE

14/08/2023

14:12:10

As

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DRAWN LMB

indicated DATE

CHECKED LMB

SHEET SIZE REVISION 0