


SITE PLAN

SCALE 1: 200

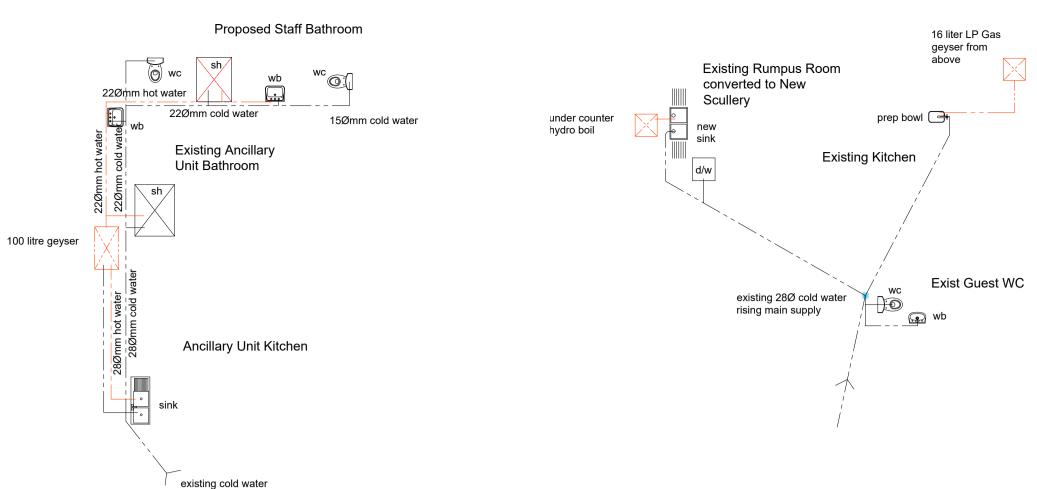

# WATER RETICULATION LAYOUT **ANCILLARY UNIT**

supply from dwelling

SCALE 1: 100

WATER RETICULATION LAYOUT **GROUND FLOOR DWELLING** SCALE 1: 100

Stormwater Management Calculations:

210 m2

560 m2

59 m2

2972 m2

 $3 \times 5250$  liter water tank = 6,6m3 each = 19,8 m2

therefore stormwater attenuation required = 20 m3

Total stormwater attenuation provided = 23,8 m3

829 m2 (27.8% of site)

= 2,0m3 each = 4,0 m3

Required stormwater attenuation = 1m3/40m2 of hardened area

Hardened Areas:

Paved Driveway

Total roofed area


Site Area

External paved areas

Total hardened area

2 x attenuation tanks

Provided stormwater attenuation

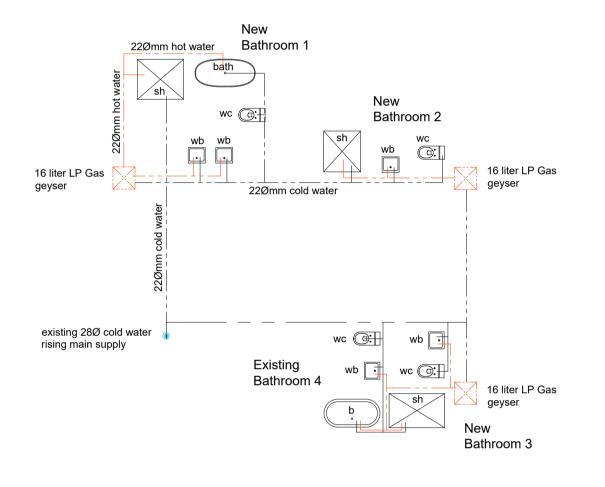

#### **Water Reticulation and Calculations**

A20 Classification: A21 Occupancy: Type of hot water generation: Hot water demand (SANS10252-1): No of Bedrooms: Total demand: Hot water storage capacity required: Capacity provided:

2 persons/bedroom Geyser and Gas Geysers 80 litres per person per day 4x2x 80I = 640 litres 640 x 50% = 320 litres (50% XA2) 100 litre resistance geyser and LP gas geysers

# WATER RETICULATION LAYOUT FIRST FLOOR DWELLING

SCALE 1: 100

## SCHEDULE OF AREAS:

SITE AREA PORTION 6 OF ERF 2753 2972 m2 ZONING: SPECIAL RESIDENTIAL 1200

### **EXISTING GROUND FLOOR:**

EXISTING COVERED PATIO 20.14 m2 (cov) EXISTING COVERED ENTRANCE 6.15 m2 (cov) EXISTING ANCILLARY UNIT 79.00 m2 (cov) EXISTING OUTBUILDING 49.96 m2 (cov) TOTAL EXISTING COVERAGE 340.02 m2 11.44%

**EXISTING FIRST FLOOR:** 

EXISTING DWELLING 151.53 m2 (far - not applicable)

PROPOSED GROUND FLOOR:

PROPOSED ENTRANCE PORTICO: 11.18 m2 - 6.15m2 (existing to be demolished)

62.68 m2 (new cov)

184,77 m2 (cov)

5.03 m2 (new cov) PROPOSED COVERED VERANDA 85.06 m2 (new cov) PROPOSED DOUBLE GARAGE

**NEW PROPOSED COVERAGE:** 152.77 m2 (proposed add cov)

TOTAL PROPOSED COVERAGE: 492.79 m2 16.58%

TOTAL PERMISSIBLE COVERAGE 1188.80 m2

TOTAL PERMISSABLE F.A.R. NOT APPLICABLE

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general notes:

dhs architecture

to construction

dimensions of site

this drawing is copyright and remains the property of

all dimensions and levels on this drawing are to be

all work is to be carried out in accordance with the

the office of the architect prior to construction

taken in preference to scaling off

all dimensions and levels are to be checked on site prior

any discrepancies on this drawing are to be reported to

national building regulations SANS 10400 parts A to Z

all retaining walls, piles footings, slabs, beams, columns

and agricultural drains to engineer's details and design

all foundations/piling to structural engineer's detail and

All foundations and existing structures to be certified by

competent person as per SANS 10400 part A1(3)(a) the main contractor to check the land surveyors drawings for confirmation of setting out levels and

building work may only commence on approval of the building plans from the local authority\_construction prior to approval will be at the risk of the owner

> Fax: 086 5800 973 Reg Number: ST2201 signature:

DEREK JOHN HAUPTFLEISCH

dhs architecture

PROPOSED ADDITIONS AND ALTERATIONS

TO EXISTING DWELLING, ON PORTION 6 OF ERF 2753, **DURBAN NORTH,** AT 23 BERKELEY CRESCENT.

**AROON PATEL HEIDI LYNN PATEL** 



signature:

drawing title: SITE PLAN **AREA SCHEDULE** WATER RETICULATION

drawing and project number: dhs2023 209 300 RevB

author: scale October 2023 1:500