



ROOF PLAN (1 : 200)

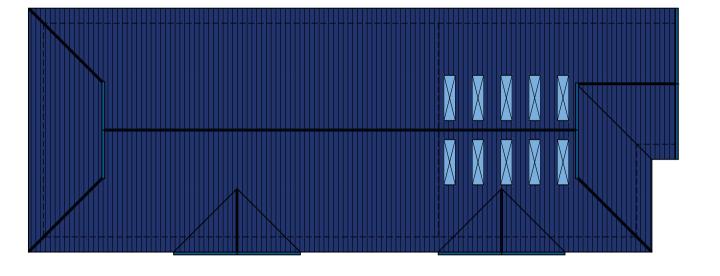


SECTION B - B

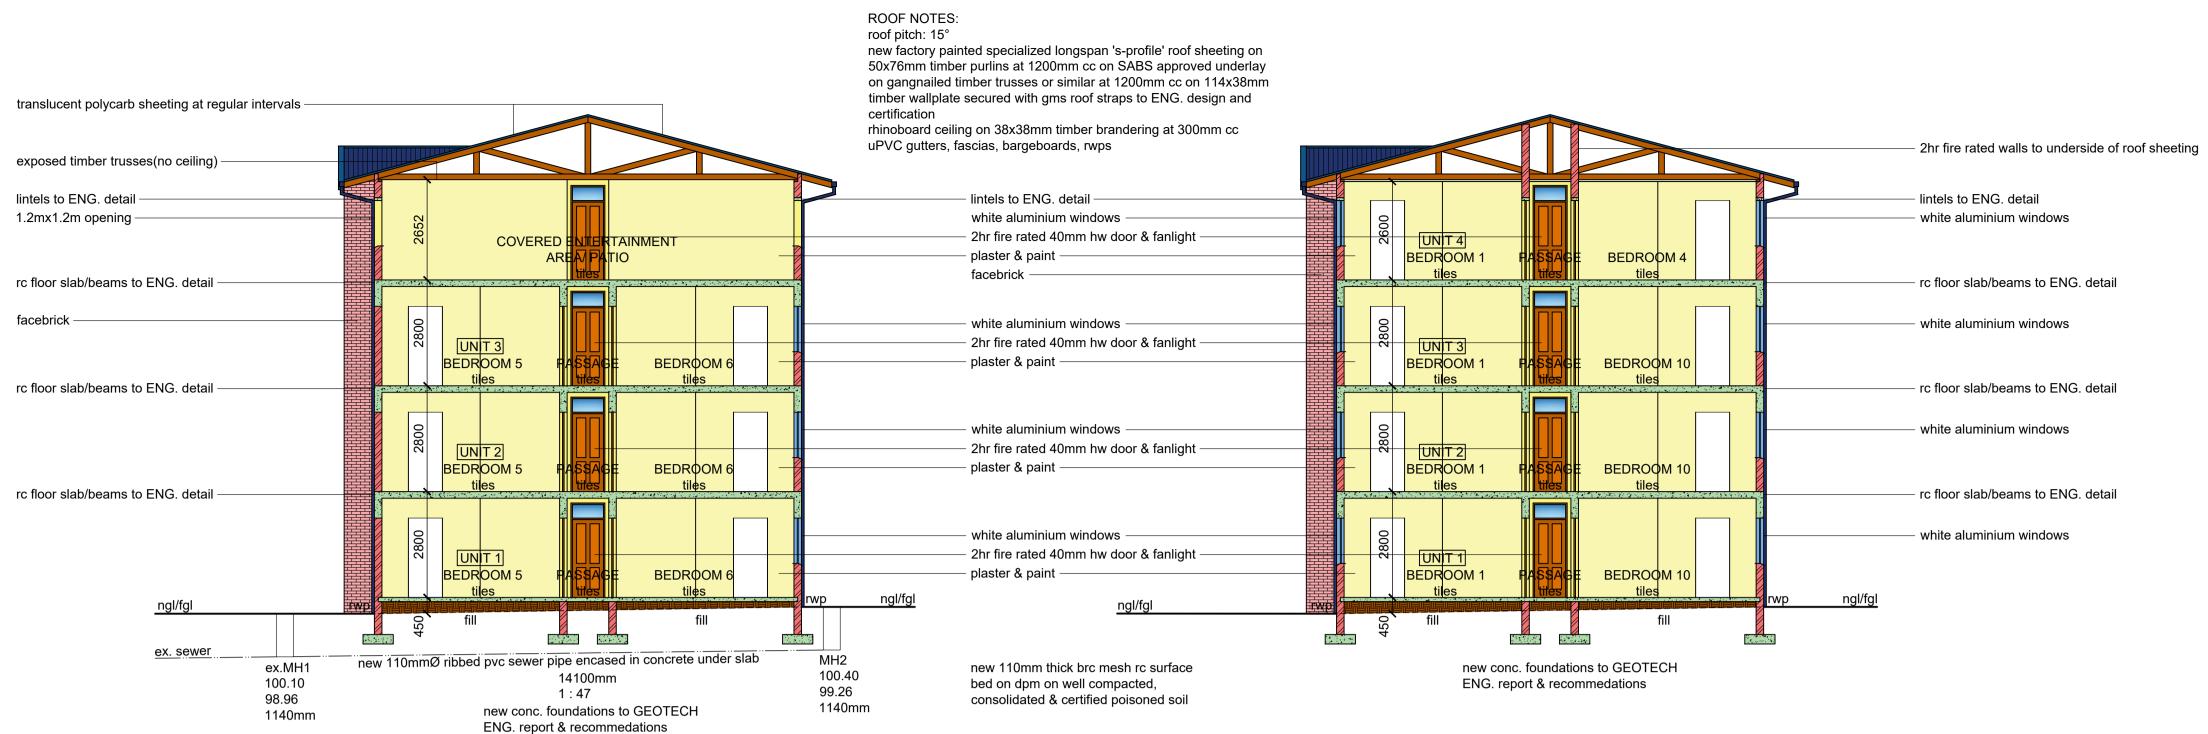

SOUTH WEST ELEVATION

SECTION A - A

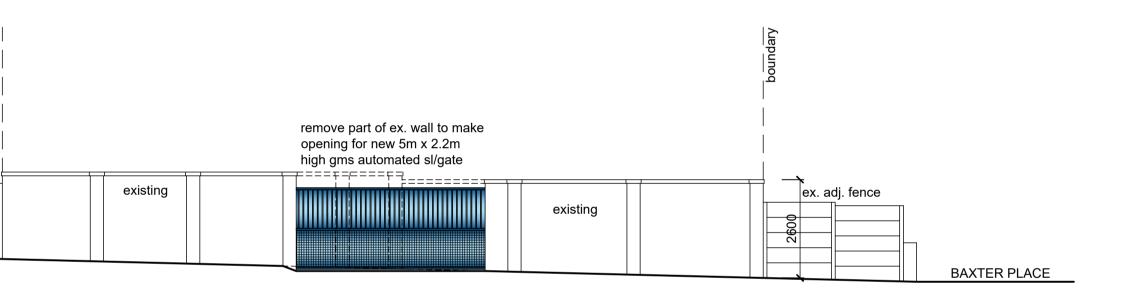



Access for fire-fighting and rescue purposes - T4.54 All copper from geyser from pressure control valve to be 25mm 1 397. 50 m² Total Area = mm) glass thickness frame Contact Number Client/s Signature x1200 clear 5mm tsg | aluminium 1042 6048 / 000 Rate No. x1200 clear 5mm tsg aluminium x1200 clear 6.3mm tsg aluminium PROPOSED NEW MULTI-STOREY x1200 obscure 6.3mm tsg aluminium x 600 obscure 6.3mm tsg aluminium **RESIDENTIAL DEVELOPMENT AT** 0x2100 2hr fire rated 40mm hw timber 26-32 CLARK ROAD ON 400 clear 6.3mm tsg timber REM OF ERF 6325 DURBAN FOR (2100 40mm hw timber x2100 40mm hw louvered timber N. DLAMINI ium windows to have thermal break framing s to have 6.3mm tsg 1 035. 00 m² **GRAHAM BRAUM** 974.00 m² ARCHITECTURAL DESIGNER 487.00 m² Pr. S. Arch. T 376. 48 m² Reg. No. ST0010 Moun 1 168. 80 m² 1 168. 17 m² 360 Umbilo Road Tel. : 031-2054142 Durban Cell : 082 454 0441 376. 48 m² 4001 340. 34 m² Email : gpbdesigners@gmail.com 340. 34 m² 340. 34 m² SCALE 1 : 100/ 1 : 200 1 397. 50 m² CHECKED : G. P. BRAUM : M. R. AZMUTH DRAWN/DESIGNED NOVEMBER 2022 DATE : 6679 / 22 / 2 of 4 10 bays Drawing No.

GENERAL NOTES Zoning - GR2 Occupancy - H3 All dimensions and levels to be determined on site prior to commencement of construction All work to comply with SANS 10400 regulations All construction by registered/responsible persons Any deviations to original approved plan will deem not to comply further without consent from the architect/ author of plans and owner is responsible Drawing to be read and not scaled Drawing to be read in conjunction with Engineers drawing All structural work(foundations, fill, surface beds, slabs, walls, cills, lintels, roofs, columns, beams, stairs, balustrades) to Engineers design and certification All new glazing to be in white aluminium and in accordance with SANS 10400 Part N Each tenant is responsible for disposing their trash into the bins provided in the Bin Areas PLUMBING NOTES Any damaged fittings to be replaced All gulley surrounds to be 150mm Sewer to be exposed before commencement of construction Manhole covers to be 75mm above ground level IE's to all bends and junctions Soil pipes to be 110mm dia. uPVC Waste pipes to be 50mm dia. uPVC Sewer under slab to be ribbed uPVC All pipes and sanitary fittings to be SABS approved All plumbing installations to be carried out by Durban-ticket registered plumbing contractor and to comply with Municipal by-laws ADDITIONAL NOTES: All separating walls to underside of rc slabs or roof sheeting Connect all new plumbing to ex. sewer HEALTH NOTES: 3 X wash troughs to be provided in the drying yard for clothes washing purposes FIRE NOTES Occupancy - H3 Safety distances - T4.2 Fire stability of structural elements - T4.7 Tenancy separating elements - T4.8 Protection of openings - T4.10 Roof assemblies and coverings - T4.12 Ceilings - T4.13 Floor covering - T4.14 Internal finishes - T4.15 Escape routes - T4.16 Exit doors - T4.17 External stairways and passages - T4.27 Lobbies, foyers, vestibules - T4.28 Marking and signposting - T4.29 Provision of emergency lighting - T4.30 Fire detection and alarm systems - T4.31 Water reticulation for fire fighting - T4.33 Hose reels - T4.34 Extinguishers - T4.37 Smoke control - T4.42 Presumed fire resistance of building materials and components - T4.55 Water pressure: 300L/min @ 3bar pressure - SANS10400 · part W **ENERGY EFFICIENCY NOTES** Water Reticulation : All internal copper to be stroke 2 All external copper to be stroke 0 Valve bracket to be min. 350mm above geyser Roof Insulation 100mm sisolation to be laid over battening of roof with a min. 100mm overlap (woolen cloth - chromadek/metal roofing) 50% Eskom - 50% energy saving induction geysers- see specialist report for calculations WINDOW AND DOOR SCHEDULE SCHEDULE OF AREAS site area(gross) site area(nett) coverage allowed(50%) TOTAL COVERAGE f.a.r allowed(1.2) TOTAL F.A.R ground storey first storey second storey third storey Total Total no. of units Total no. of kitchens Parking provided

item	no.	size (
w1	7	1800>
w2	51	1200>
w3	4	600>
w4	1	600>
w5	58	500>
d1+	10	900
f/light		900>
d2	59	900>
d3	1	900
new timber/alumini		
all shower cubicles		