


EX ROOF (11) Replace external balustrade with internal glass balustrade to (3) New balcony to engs. details specialists detail in study rooms. on guest suite. Ex. Ridge height EX ROOF U/S of ceiling Ex. rwdp 11)New internal 1000mm high glass balustrade to specialist. EX. STUDY ROOM 1 \rightarrow EX. STUDY ROOM 2 FFL: 95.489 PROP. FIRST Stairs: FLOOR Prop. P&P FFL: 95.489 sg sg sg width:800mm T: 14 x 270mm First floor level R: 15 x 150mm To comply with **EX. STUDY ROOM 1** EX. STUDY ROOM 2 SANS part M Prop. Timber 16.07m² ✓ U/S of ceiling Prop. Timber 17.51m² · 4 Change window size and position in ex. study room2. 16 Change ceiling to new floor joists. -NEW BALCONY Ex. D Ex. D **ADDITION** EX. GUEST BEDROOM 1 EX. GUEST BEDROOM 2 7 Change size (550mm x 1210mm)and position of EX. GROUND FLOOR
Ex. P&P
FFL: 92.798 VOID/ Ex. external balustrade. roof windows in study rooms. UNDER 14)Remove 180mm drywall and Ground floor level replace with 90mm drywall. 8 Ex. Rc slab -_✓ NGL EX. GARAGE Ex. P&P FFL: 90.000 EX-ROOF Basement Level 3721 3431 Ex. surface bed 10126 Ex. foundations Ex. foundations

SECTION ON EE - GUEST SUITES & GARAGE BUILDING FIRST FLOOR PLAN - GUEST SUITES & GARAGE BUILDING 1:50 @ A1

1:50 @ A1

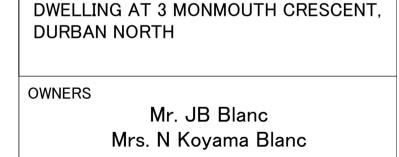

DEVIATION TO APPROVED PLANS TO

AMANDA LEAD SACAP REG. No. 5027 Pr.Arch. 54 EDMONDS ROAD, GLENWOOD, DURBAN, 4001.

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architects www.leadarchitects.co.za

Revisions

STREET ADDRESS 3 Monmouth Cresent, Durban North

CADASTRAL DESCRIPTION ERF 2701 OF DURBAN NORTH

NAMES & SIGNATURES

Architect & Applicant:

Owner

DRAWING

PROPOSED FLATLET GROUND FLOOR PLAN, FIRST FLOOR PLAN, SECTION D-D & SECTION E-E.

DEVIATION PLANS


Project Number: 2103 Date: 11 November 2022 Drawn: SN Thusi Checked: AK Lead Scale: As shown @ A1


DWG No:

2103_4.3_103_A

REV


Α

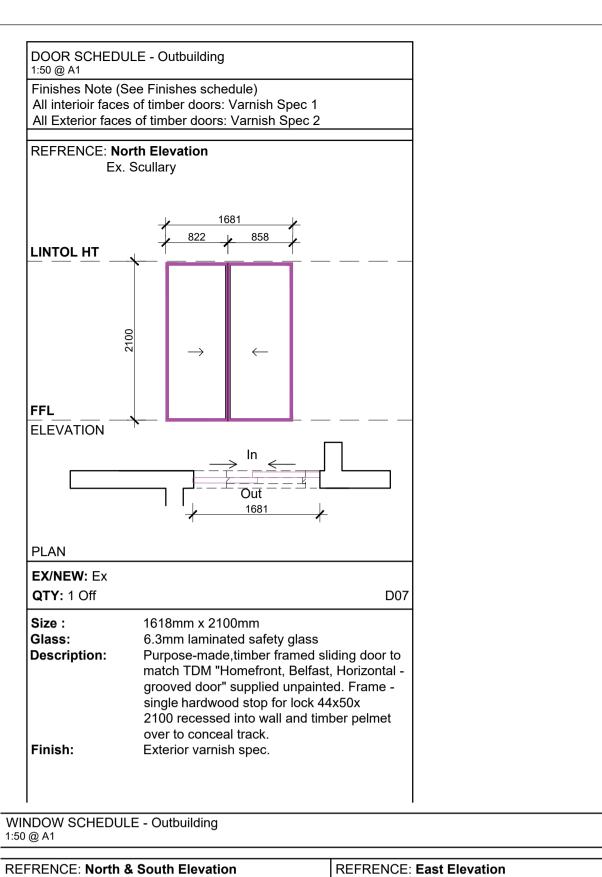

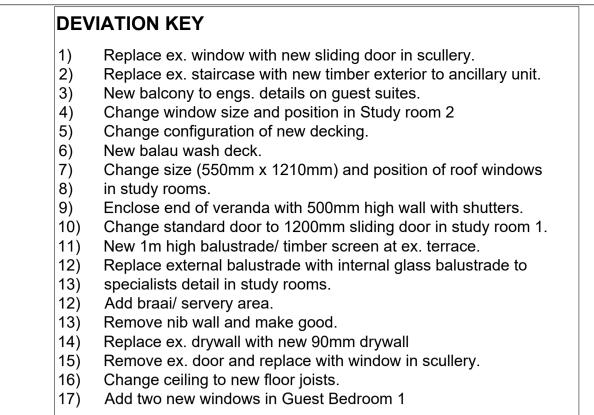


Revisions

No deviations made to Electrical layout. All as per previously approved plans.

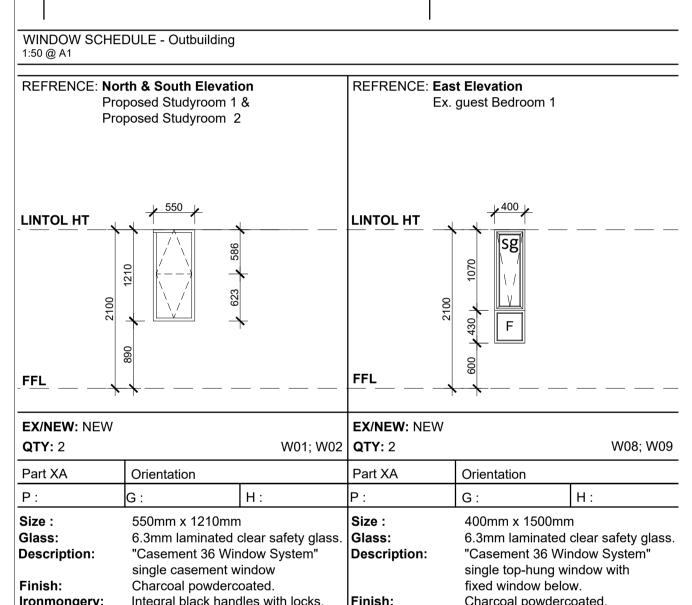


SITE OPERATIONS

1. All Works to comply with SANS Part F

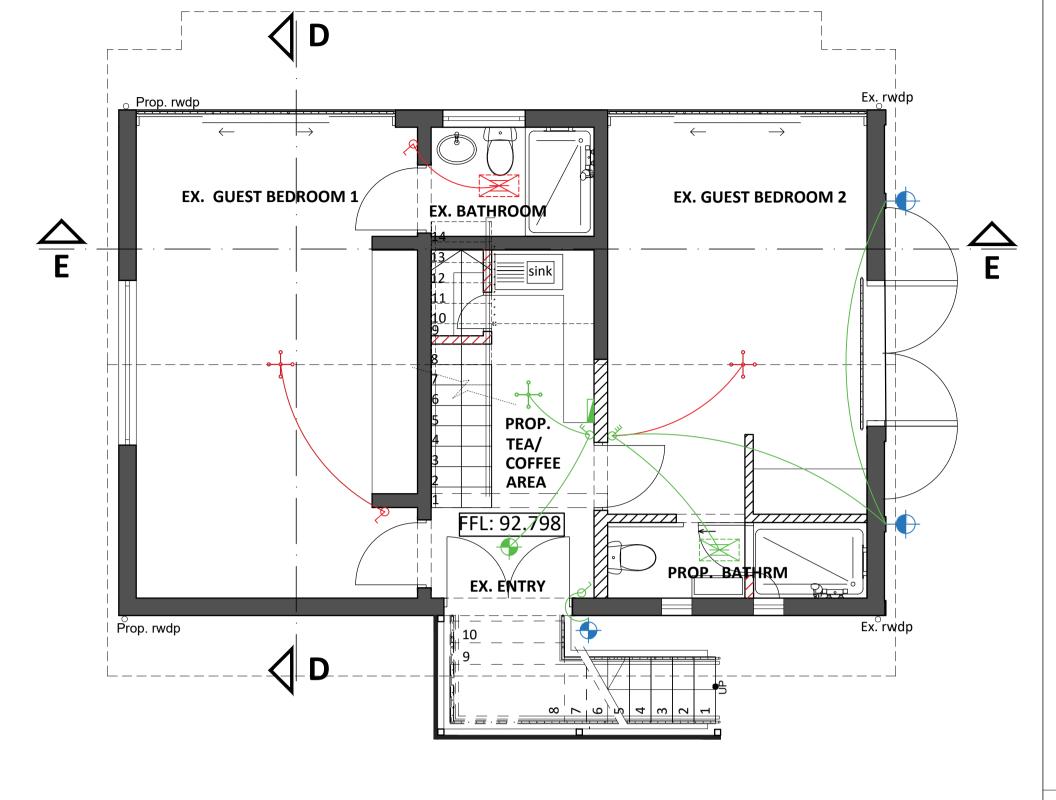

GROUND FLOOR PLAN - GUEST SUITES & GARAGE BUILDING ELECRICAL LAYOUT 1:50 @ A1

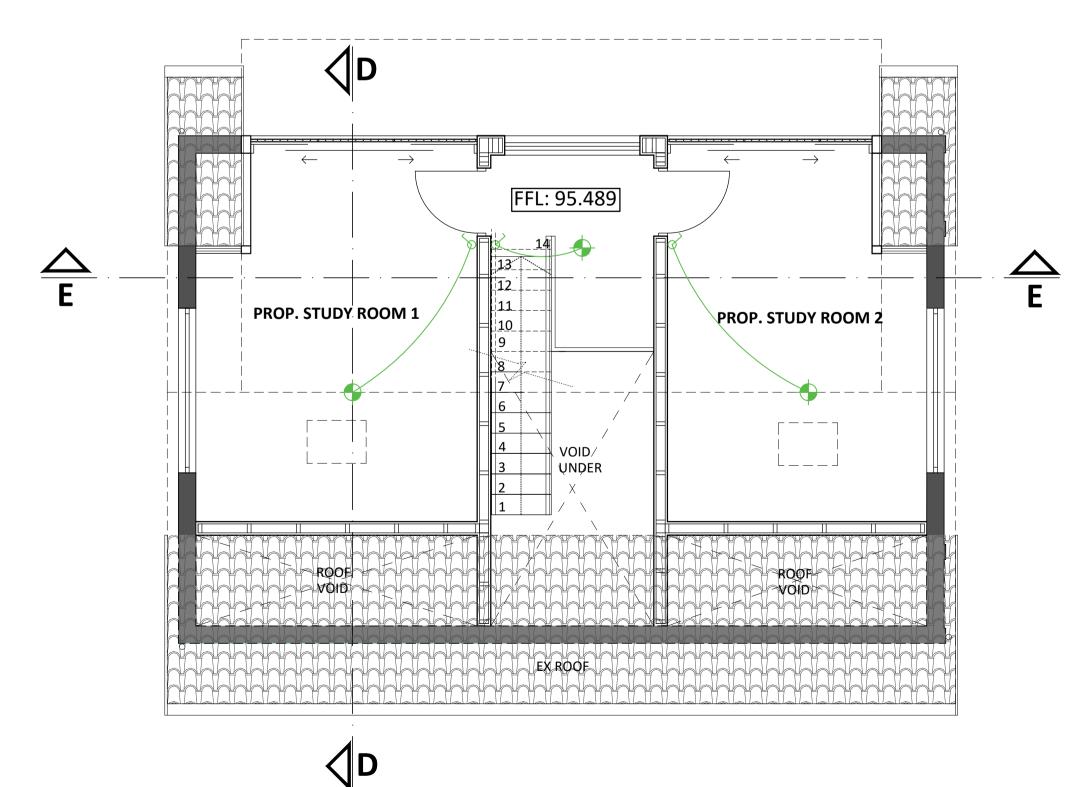

FIRST FLOOR PLAN - GUEST SUITES & GARAGE BUILDING ELECTRICAL LAYOUT 1:50 @ A1



Revisions

Deviations for submission to Authorities 18.11.2022

Description

AMANDA LEAD SACAP REG. No. 5027 Pr.Arch. 54 EDMONDS ROAD, GLENWOOD, DURBAN, 4001. TEL: (031) 205 1410 EML: amanda@leadarchitects.co.za

PROPOSED ADDITIONS/ALTERATIONS TO DWELLING AT 3 MONMOUTH CRESCENT, DURBAN NORTH

OWNERS

Mr. JB Blanc Mrs. N Koyama Blanc

STREET ADDRESS

3 Monmouth Cresent, Durban North

CADASTRAL DESCRIPTION

ERF 2701 OF DURBAN NORTH

NAMES & SIGNATURES

Architect & Applicant:

Owner


DRAWING

PROPOSED ELECTRICAL LAYOUT, WINDOW AND DOOR **SCHEDULE**

REV

Project Number: 2103 Date: 11 November 2022 Drawn: SN Thusi Checked: AK Lead Scale: As shown @ A1

DWG No: 2103_04_104

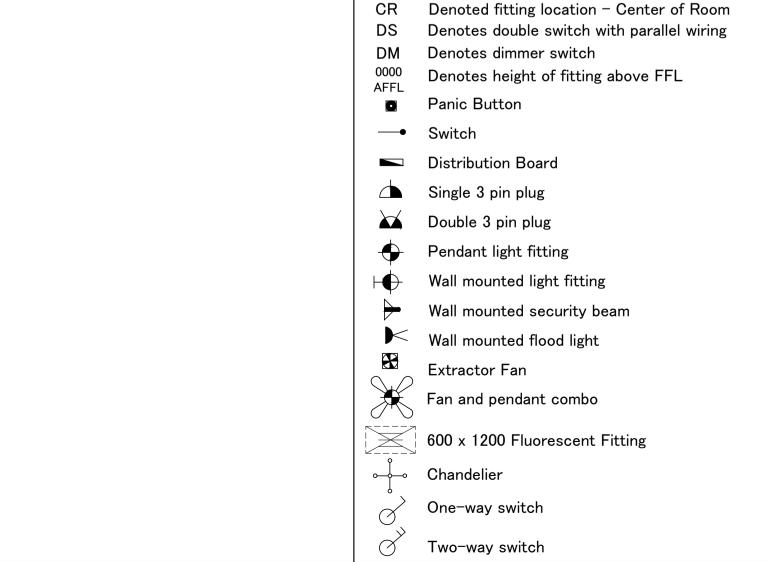

Integral black handles with locks. Charcoal powdercoated. Integral black handles with locks **ELECTRICAL LEGEND** GENERAL NOTES Denoted security fitting location (colour blue) 1. All work to comply with the SANS 10400. All materials used to Denoted new electrical fitting location (colour green) be of SABS approved approved. Denoted existing electrical fitting (colour red) 2. All dimensions and levels to be checked on site. EX Denotes existing fitting All dimensions to comply with SANS 10400 Part C Drawings are not to be scaled. 4. All structural works to be to engineers detail and spec and under their supervision. 5. All sliding and sliding folding doors to be safety glass and to with SANS 10400 Part N. All Glazing in doors and windows to comply with the requirements of SANS 10400 Part N with respect to the provision of safety All waterproofing to be installed by a qualified person to the manufacturers spec & detail All internal walls are generally plastered and painted. 9. Two courses of brick force minimum to be built in at window & door head levels & @ cill levels where possible. 10. Any discrepancies to be immediately brought to the attention of the architect. 11. All structural components - foundations, retaining walls, lintols, beams, roof structure, slabs and stairs - to be designed by competent person (Structures) and to comply with detailed requirements of Parts B, H, J, K, L, M & N of SANS 10400. 12. All dimensions work to comply with Parts D & E of SANS 13. All site work to comply with Parts F & G of SANS 10400. 14. All non-masonry external walls to achieve minimum R-value of 1.9 (4.4.3.1 of Part XA of SANS 10400). 15. All new timber to be treated against wood eating insects with approved product strictly to manufacturers specification. 16. All steel to be galvanised, primed and painted with enamel to manufacturer's specification.