


SCHEDULES OF AREAS LOT 7292


SITE AREA	69	2.00					
ZONING — General Busine	ess 2						
PERMISSIBLE COVERAGE	0.0						
PERMISSIBLE FAR	2.00	1384.00					
EXIST. COVERAGE	30.5%	211.92					
EXIST. FAR	.305	211.92					
NEW COVERAGE	39.96%	276.54					
NEW FAR	.570	392.83					
RESIDENCE AREA							
EX. OUTBUILDING			COV.	FAR			
EX. DOUBLE GARAGE / V	VC/SHW	58.67	58.67	58.67	*	SURVEYED	SIZE
EX. GROUND FLOOR OF	FICES						
OFFICES (EX. SINGLE STO	REY BLDG)	148.13	148.13	148.13	*	SURVEYED	SIZE
COVERED ENTRANCE POR	CH	5.12	5.12	5.12	*	SURVEYED	SIZE
EX. BLD'S SUB- TOTA	4L	211.92	211.92	211.92	*	SURVEYED	SIZE
NEW ADDITIONS - GRO	UND FLOOF						
STAIRCASE & ENTR. FOYI	13.30	13.30	13.30				
CARPORT		33.00	33.00	33.00			
STORES		15.12	15.12	15.12			
STAFF ABLUTIONS	3.20	3.20	3.20				
NEW ADD GRD. FL. Sub—Total		64.62	64.62	64.62			
NEW ADDITIONS - FIRS	ST FLOOR						
D/V STAIRCASE, LANDING, CORRIDOR		13.61	0	13.61			
NEW OFFICES		75.00	0	75.00			
EQUIPMENT STORE & BIC		10.70		10.70			
STAFF ABLUTIONS		7.56	0	7.56			
BALCONY		10.05	0	10.05			
NEW ADD FIRST FL. Sub—Total		116.29	0	116.29			
GRAND - TOTALS	392.83	276.54	392.83				
IN HAND	N/A	N/A	991.17				
NEW ADDS TOTALS	180.91	64.62	180.91				

ZONED - GENERAL BUSINESS 2 APPROVED ON 22.03.2022 AS PER DECISION NOTICE APPLICATION # LUM20210840002/CS (PREVIOUS ZONING - GR 2)

OCCUPANCY CLASSIFICATION G1 - OFFICES

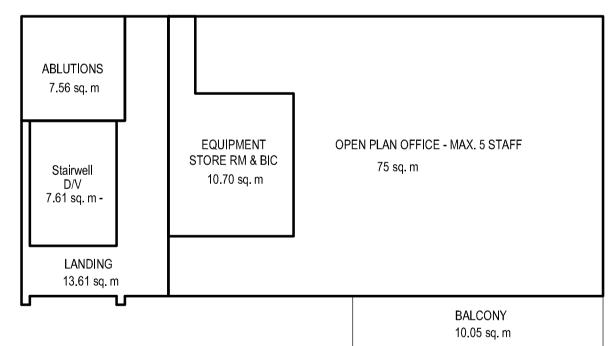

FIRST STOREY PLAN - AREA OVERLAY SCALE: 1:100

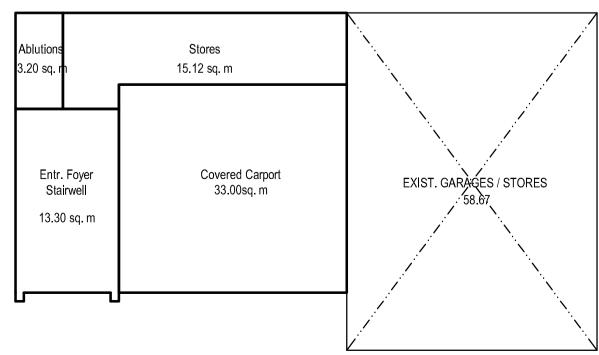

GROUND STOREY PLAN - AREA OVERLAY SCALE: 1: 100

Project

PROPOSED ADDITIONS & ALTERATIONS

TO EXIST. OUTBUILDING WITH NEW COV. PARKING
& CONVERSION thereof TO FIRST FLOOR OFFICES

& CONVERSION thereof TO FIRST FLOOR OFFICES

The Trustees of the
COVENANT FAMILY TRUST

ERF 7292 DURBAN

332 UMBILO ROAD

drawing title

REV. DATE BY

28.11.22 RBJ 1. AMAFA SUBMISSION

REVISION

SITE PLAN
AREA SCHEDULE & OVERLAY
SCALE 1:100

Phase

BUILDING APPLICATION SET PHASE - AMAFA APPLICATION



prof. senior arch. tech.


SACAP Reg: ST 2293

44 Frederick Ave,
Marlborough Park
Durban 4052

031— 466 3841

owner




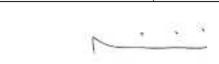

All dimensions and levels are to be checked on site prior to commencement of construction. Figured dimensions are to be taken in preference to scaling off the drawing. Any discrepancies are to be reported to the Prof. Technologist.

drawing no. S001 rev. 1 date OCT, 2022

scale 1:100 project no drawn RBJ 106

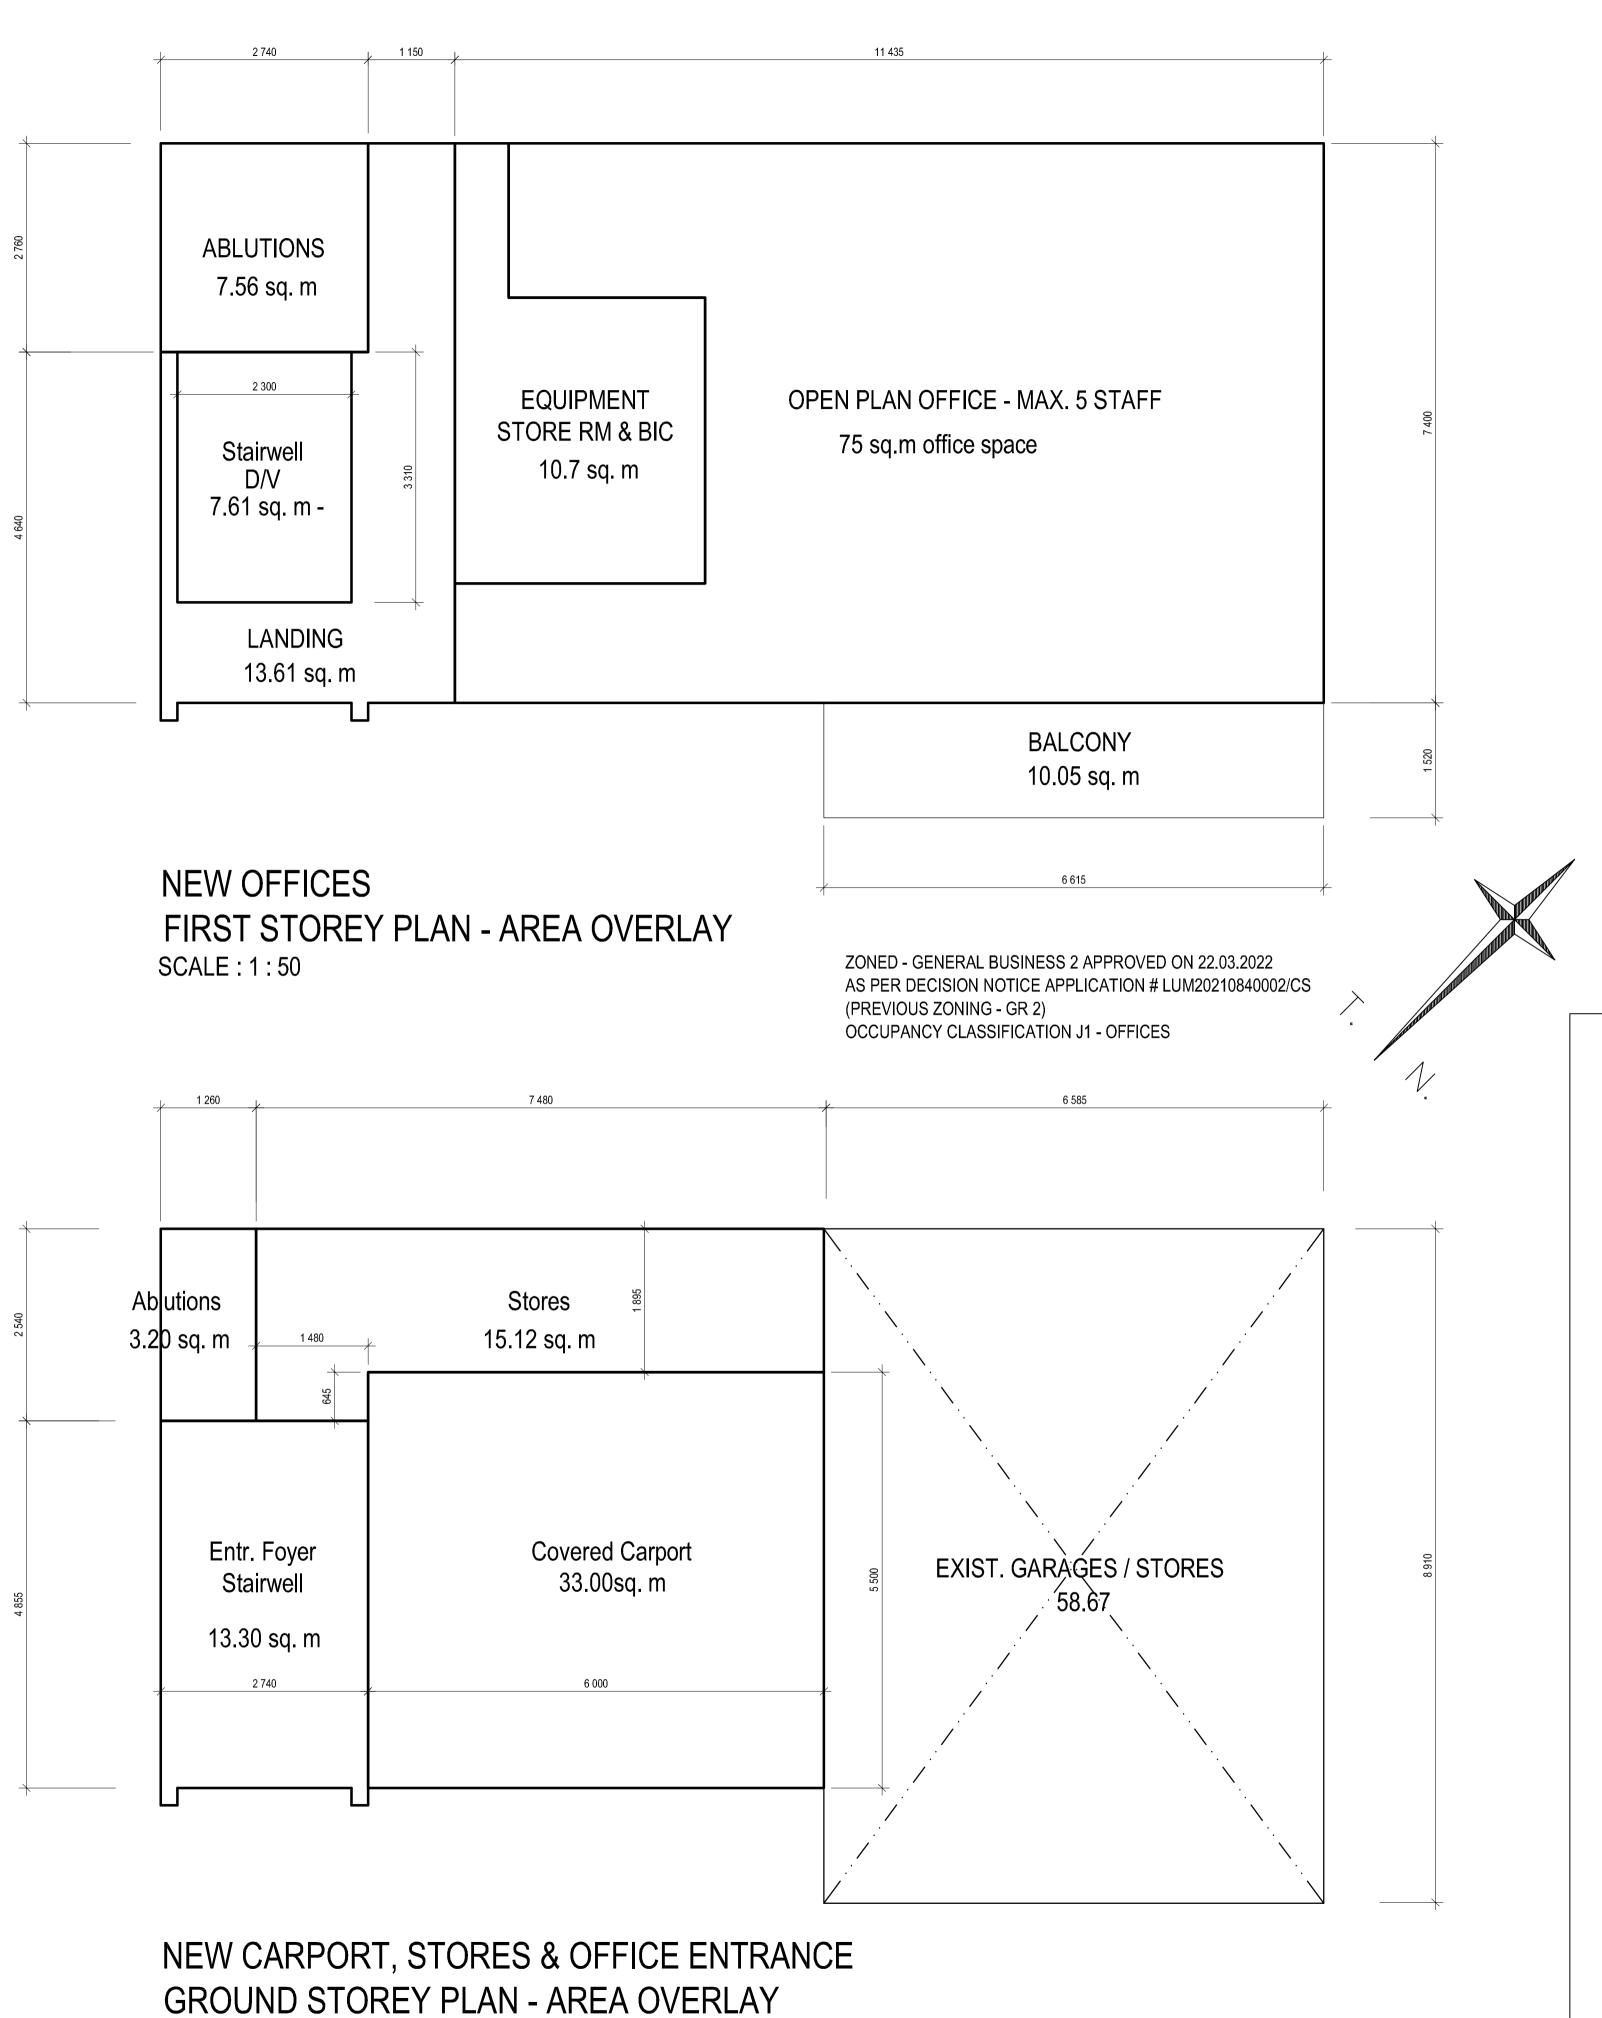

SCALE: 1:50

SCHEDULES OF AREAS LOT 7292

SITE AREA	69	2.00					
ZONING — General Busine	ess 2						
PERMISSIBLE COVERAGE	N/A	0.0					
PERMISSIBLE FAR	2.00	1384.00					
EXIST. COVERAGE	30.5%	211.92					
EXIST. FAR	.305	211.92					
NEW COVERAGE	39.96%	276.54					
NEW FAR	.570	392.83					
RESIDENCE AREA							
EX. OUTBUILDING			COV.	FAR			
EX. DOUBLE GARAGE / N	VC/SHW	58.67	58.67	58.67	*	SURVEYED	SIZE
EX. GROUND FLOOR O	FFICES						
OFFICES (EX. SINGLE STO	REY BLDG)	148.13	148.13	148.13	*	SURVEYED	SIZE
COVERED ENTRANCE POR	CH	5.12	5.12	5.12	*	SURVEYED	SIZE
EX. BLD'S SUB— TOT.	AL	211.92	211.92	211.92	*	SURVEYED	SIZE
NEW ADDITIONS - GRO	UND FLOOF	X					
STAIRCASE & ENTR. FOYER		13.30	13.30	13.30			
CARPORT		33.00	33.00	33.00			
STORES		15.12	15.12	15.12			
STAFF ABLUTIONS		3.20	3.20	3.20			
NEW ADD GRD. FL. S	ub—Total	64.62	64.62	64.62			
	T 51 005						
NEW ADDITIONS - FIRS							
D/V STAIRCASE, LANDING, CORRIDOR		13.61	0	13.61			
NEW OFFICES		75.00	0	75.00			
EQUIPMENT STORE & BIC		10.70	0	10.70			
STAFF ABLUTIONS		7.56	0	7.56			
BALCONY NEW ADD FIRST FL. Sub. Total		10.05	0	10.05 116.29			
NEW ADD FIRST FL. S	<u>IDJOI —aua</u>	116.29	0	110.29			
GRAND — TOTALS		392.83	276.54	392.83			
IN HAND		N/A	N/A	991.17			
NEW ADDS TOTALS		180.91	64.62	180.91			

Project
PROPOSED ADDITIONS & ALTERATIONS
TO EXIST. OUTBUILDING WITH NEW COV. PARKING
& CONVERSION thereof TO FIRST FLOOR OFFICES
The Trustees of the
COVENANT FAMILY TRUST

ERF 7292 DURBAN
332 UMBILO ROAD

drawing title

REV. DATE BY

02.11.22 RBJ 1. AMAFA SUBMISSION

AREA OVERLAY
NEW GROUND & FIRST STOREY PLANS
SCALE 1:50


BUILDING APPLICATION SET PHASE - AMAFA APPLICATION



prof. senior arch. tech SACAP Reg: ST 2293 44 Frederick Ave, Marlborough Park Durban 4052 031— 466 3841





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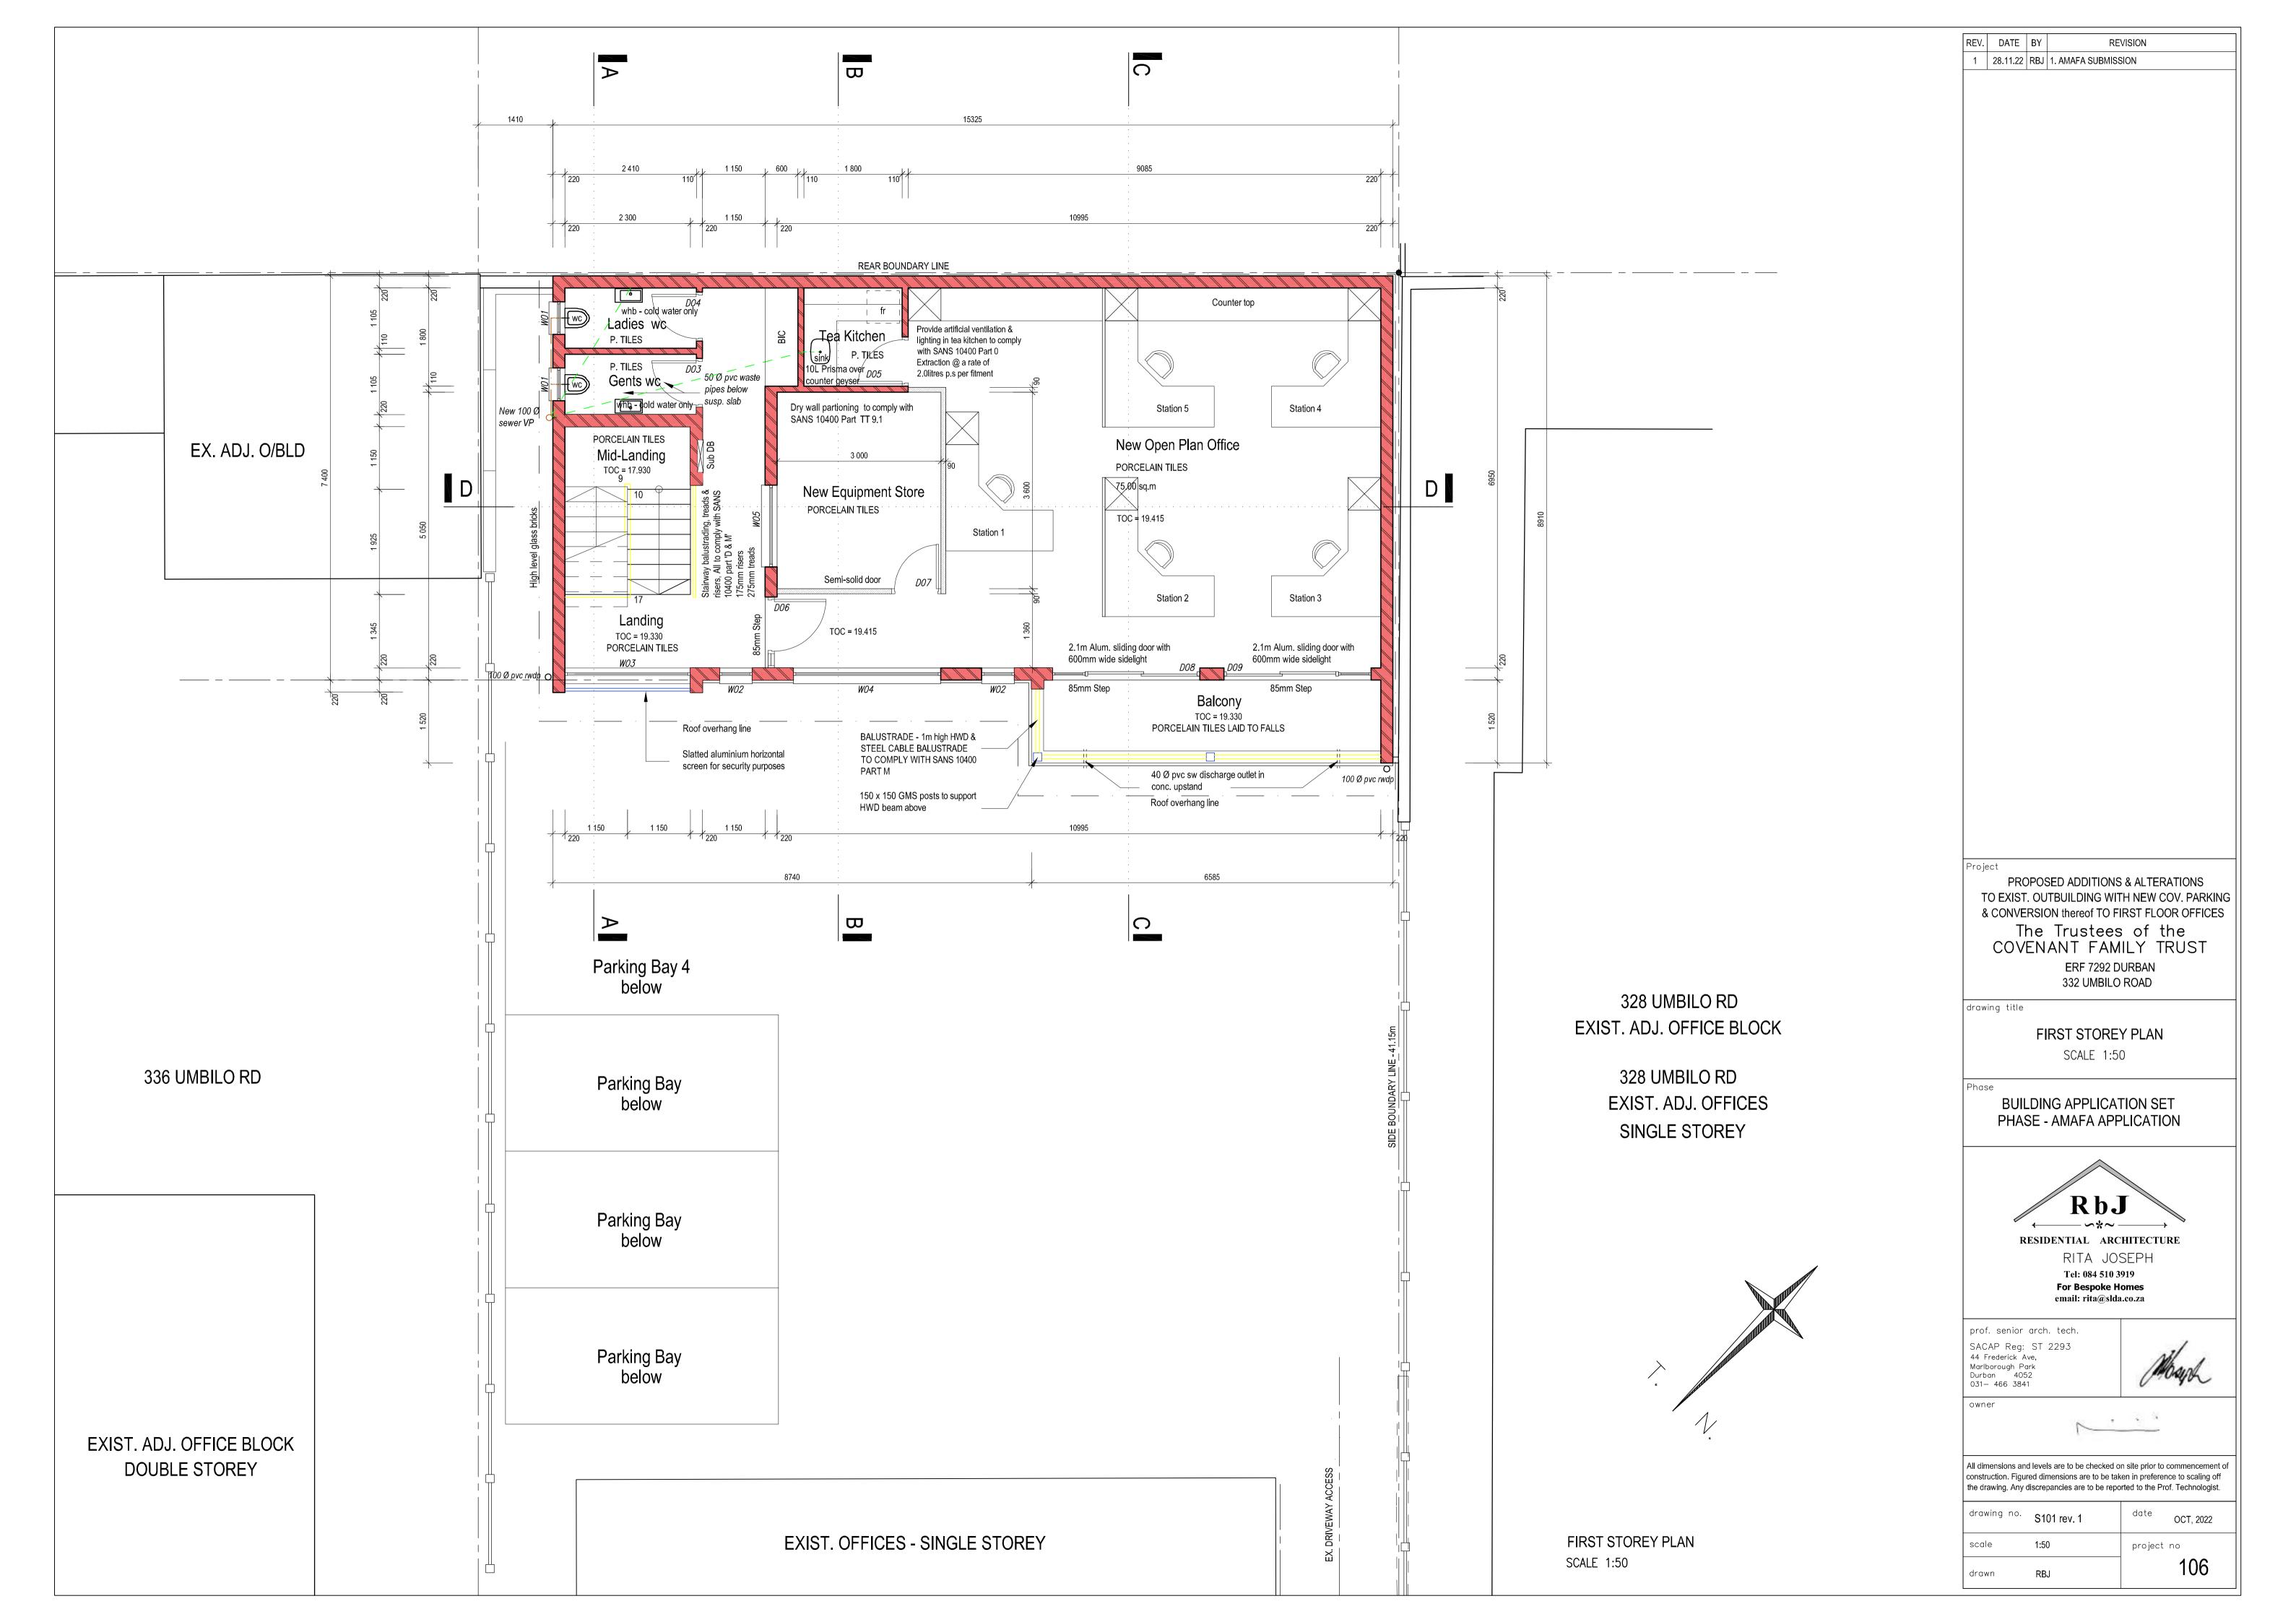


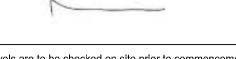
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drawing no.	S002 rev. 1	date OCT, 2022
scale	1:50	project no
drawn	RBJ	106






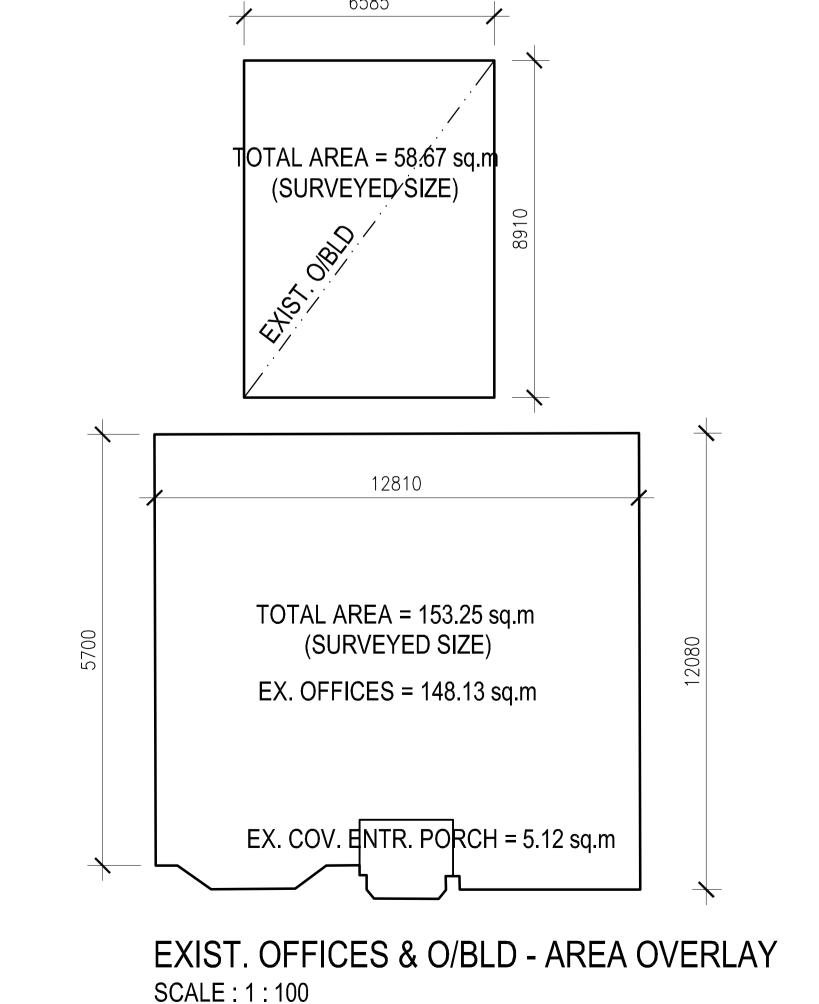


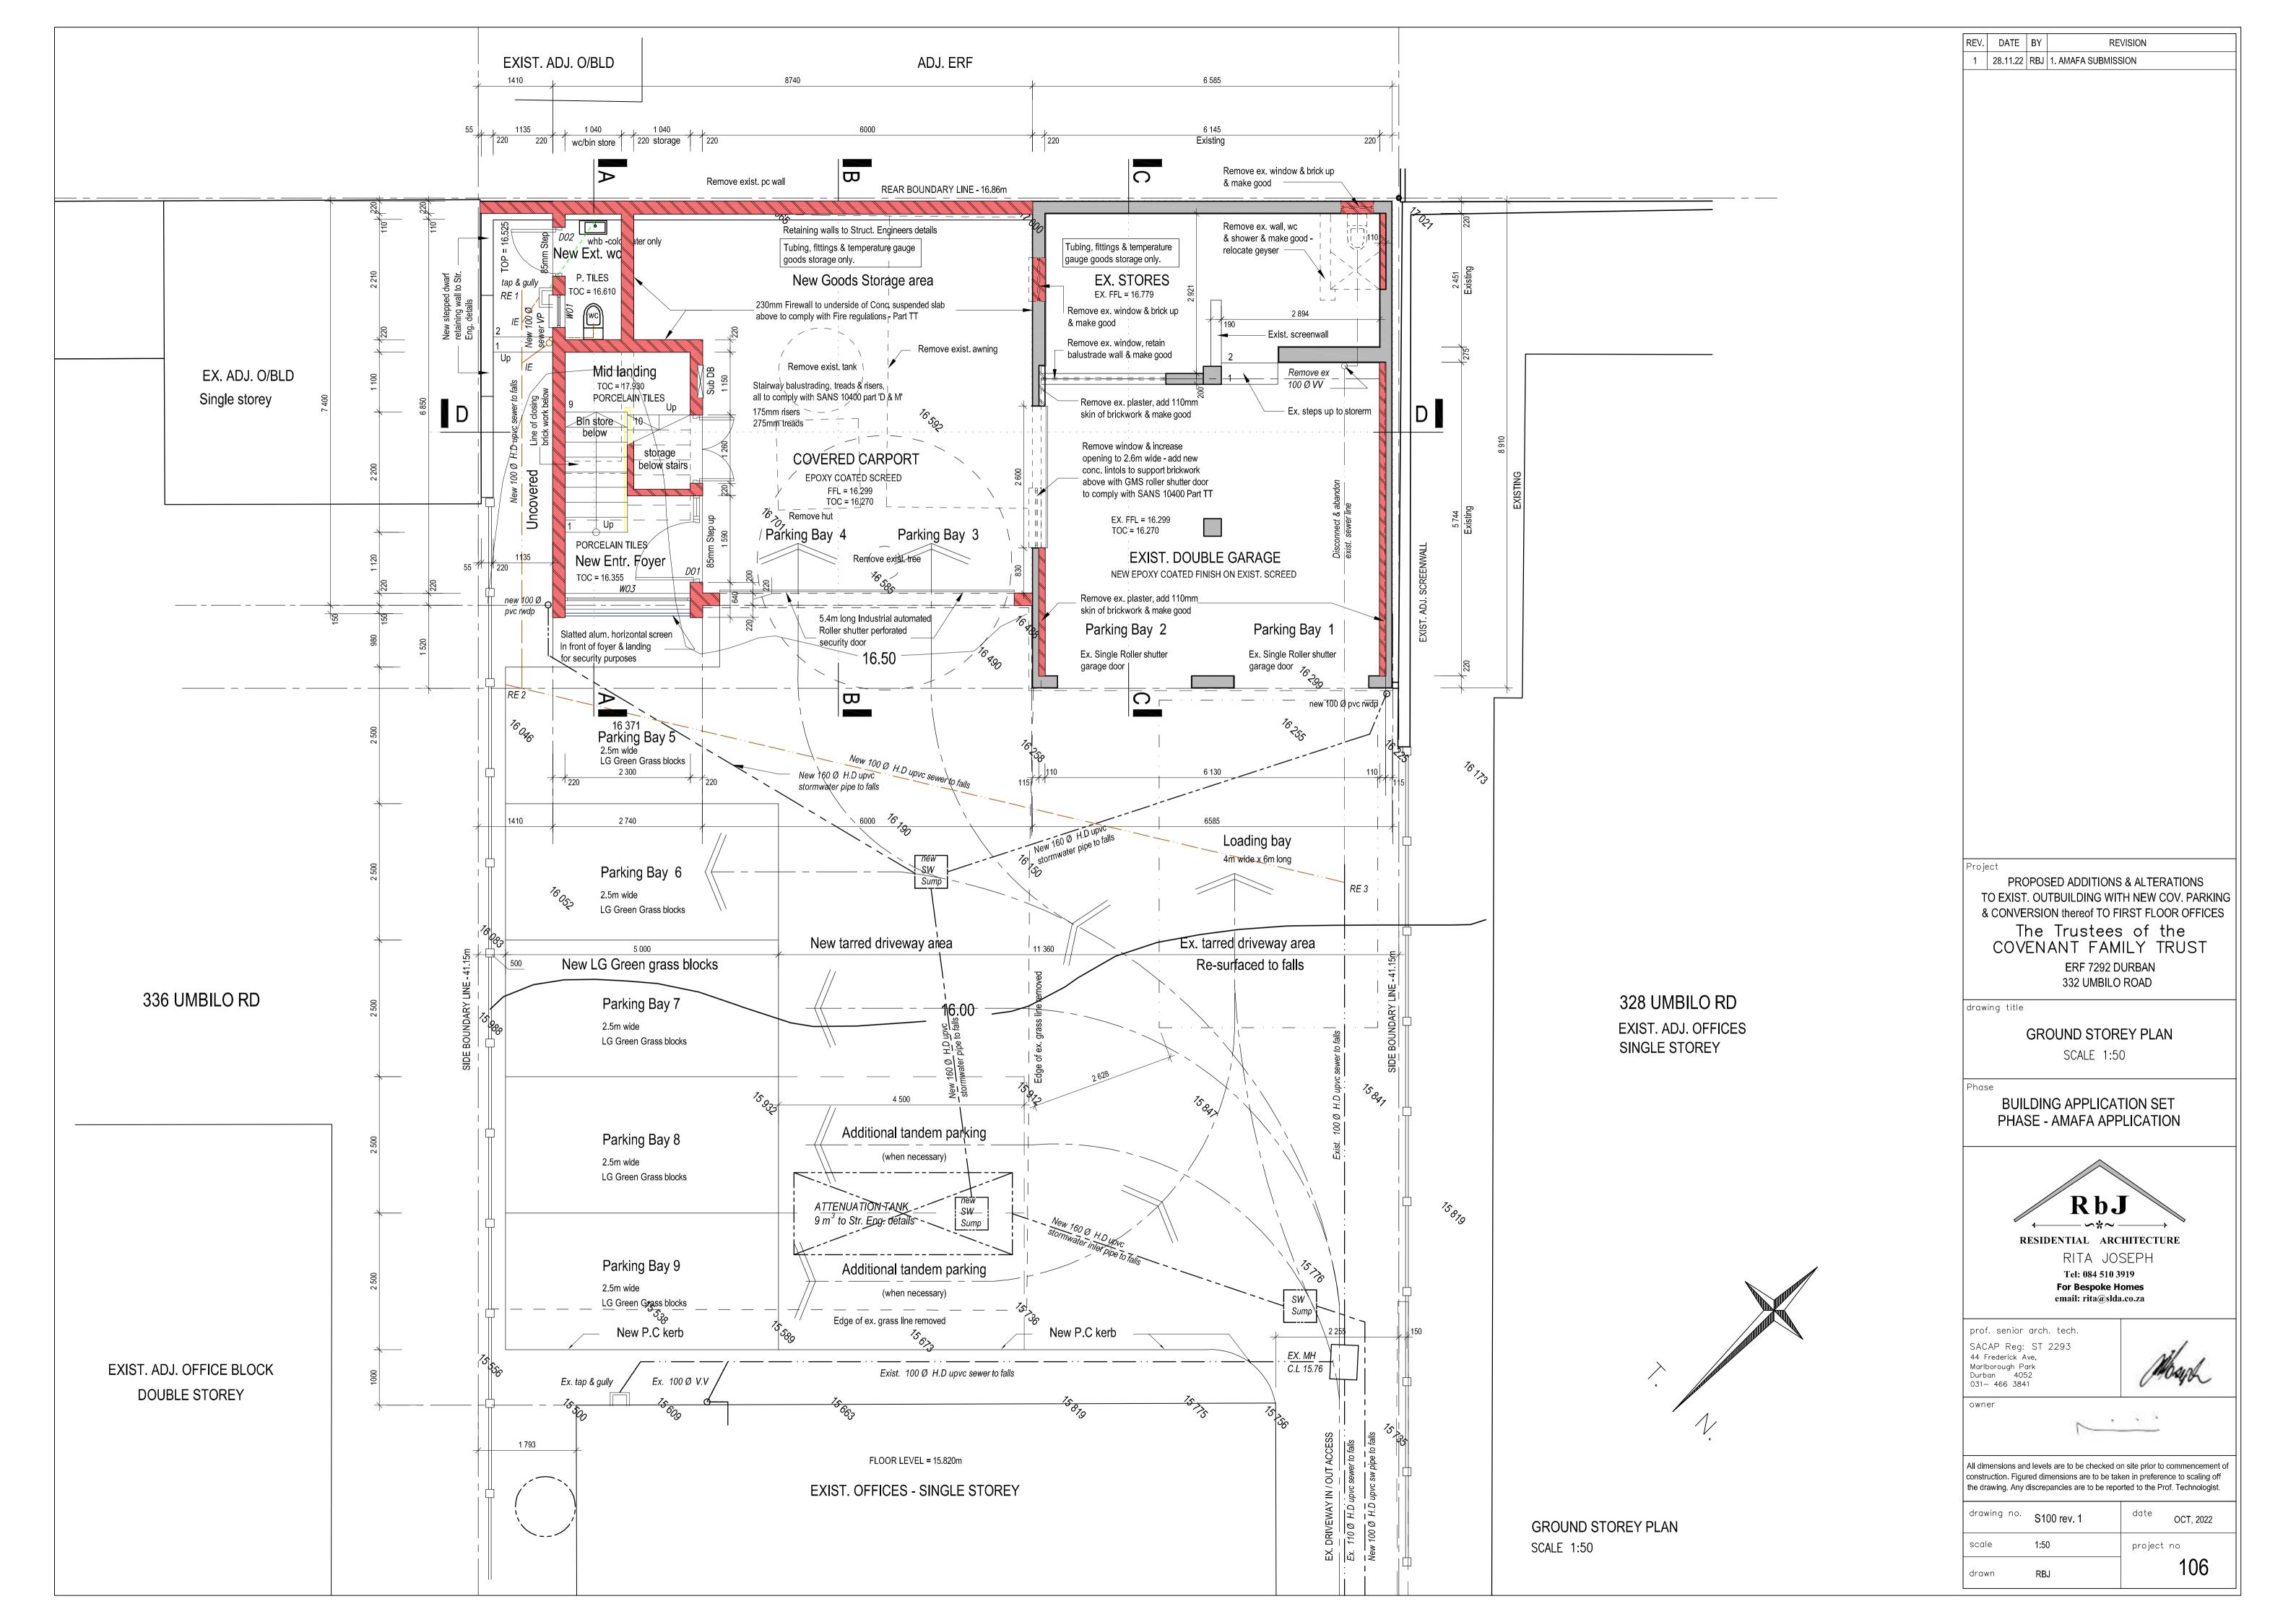

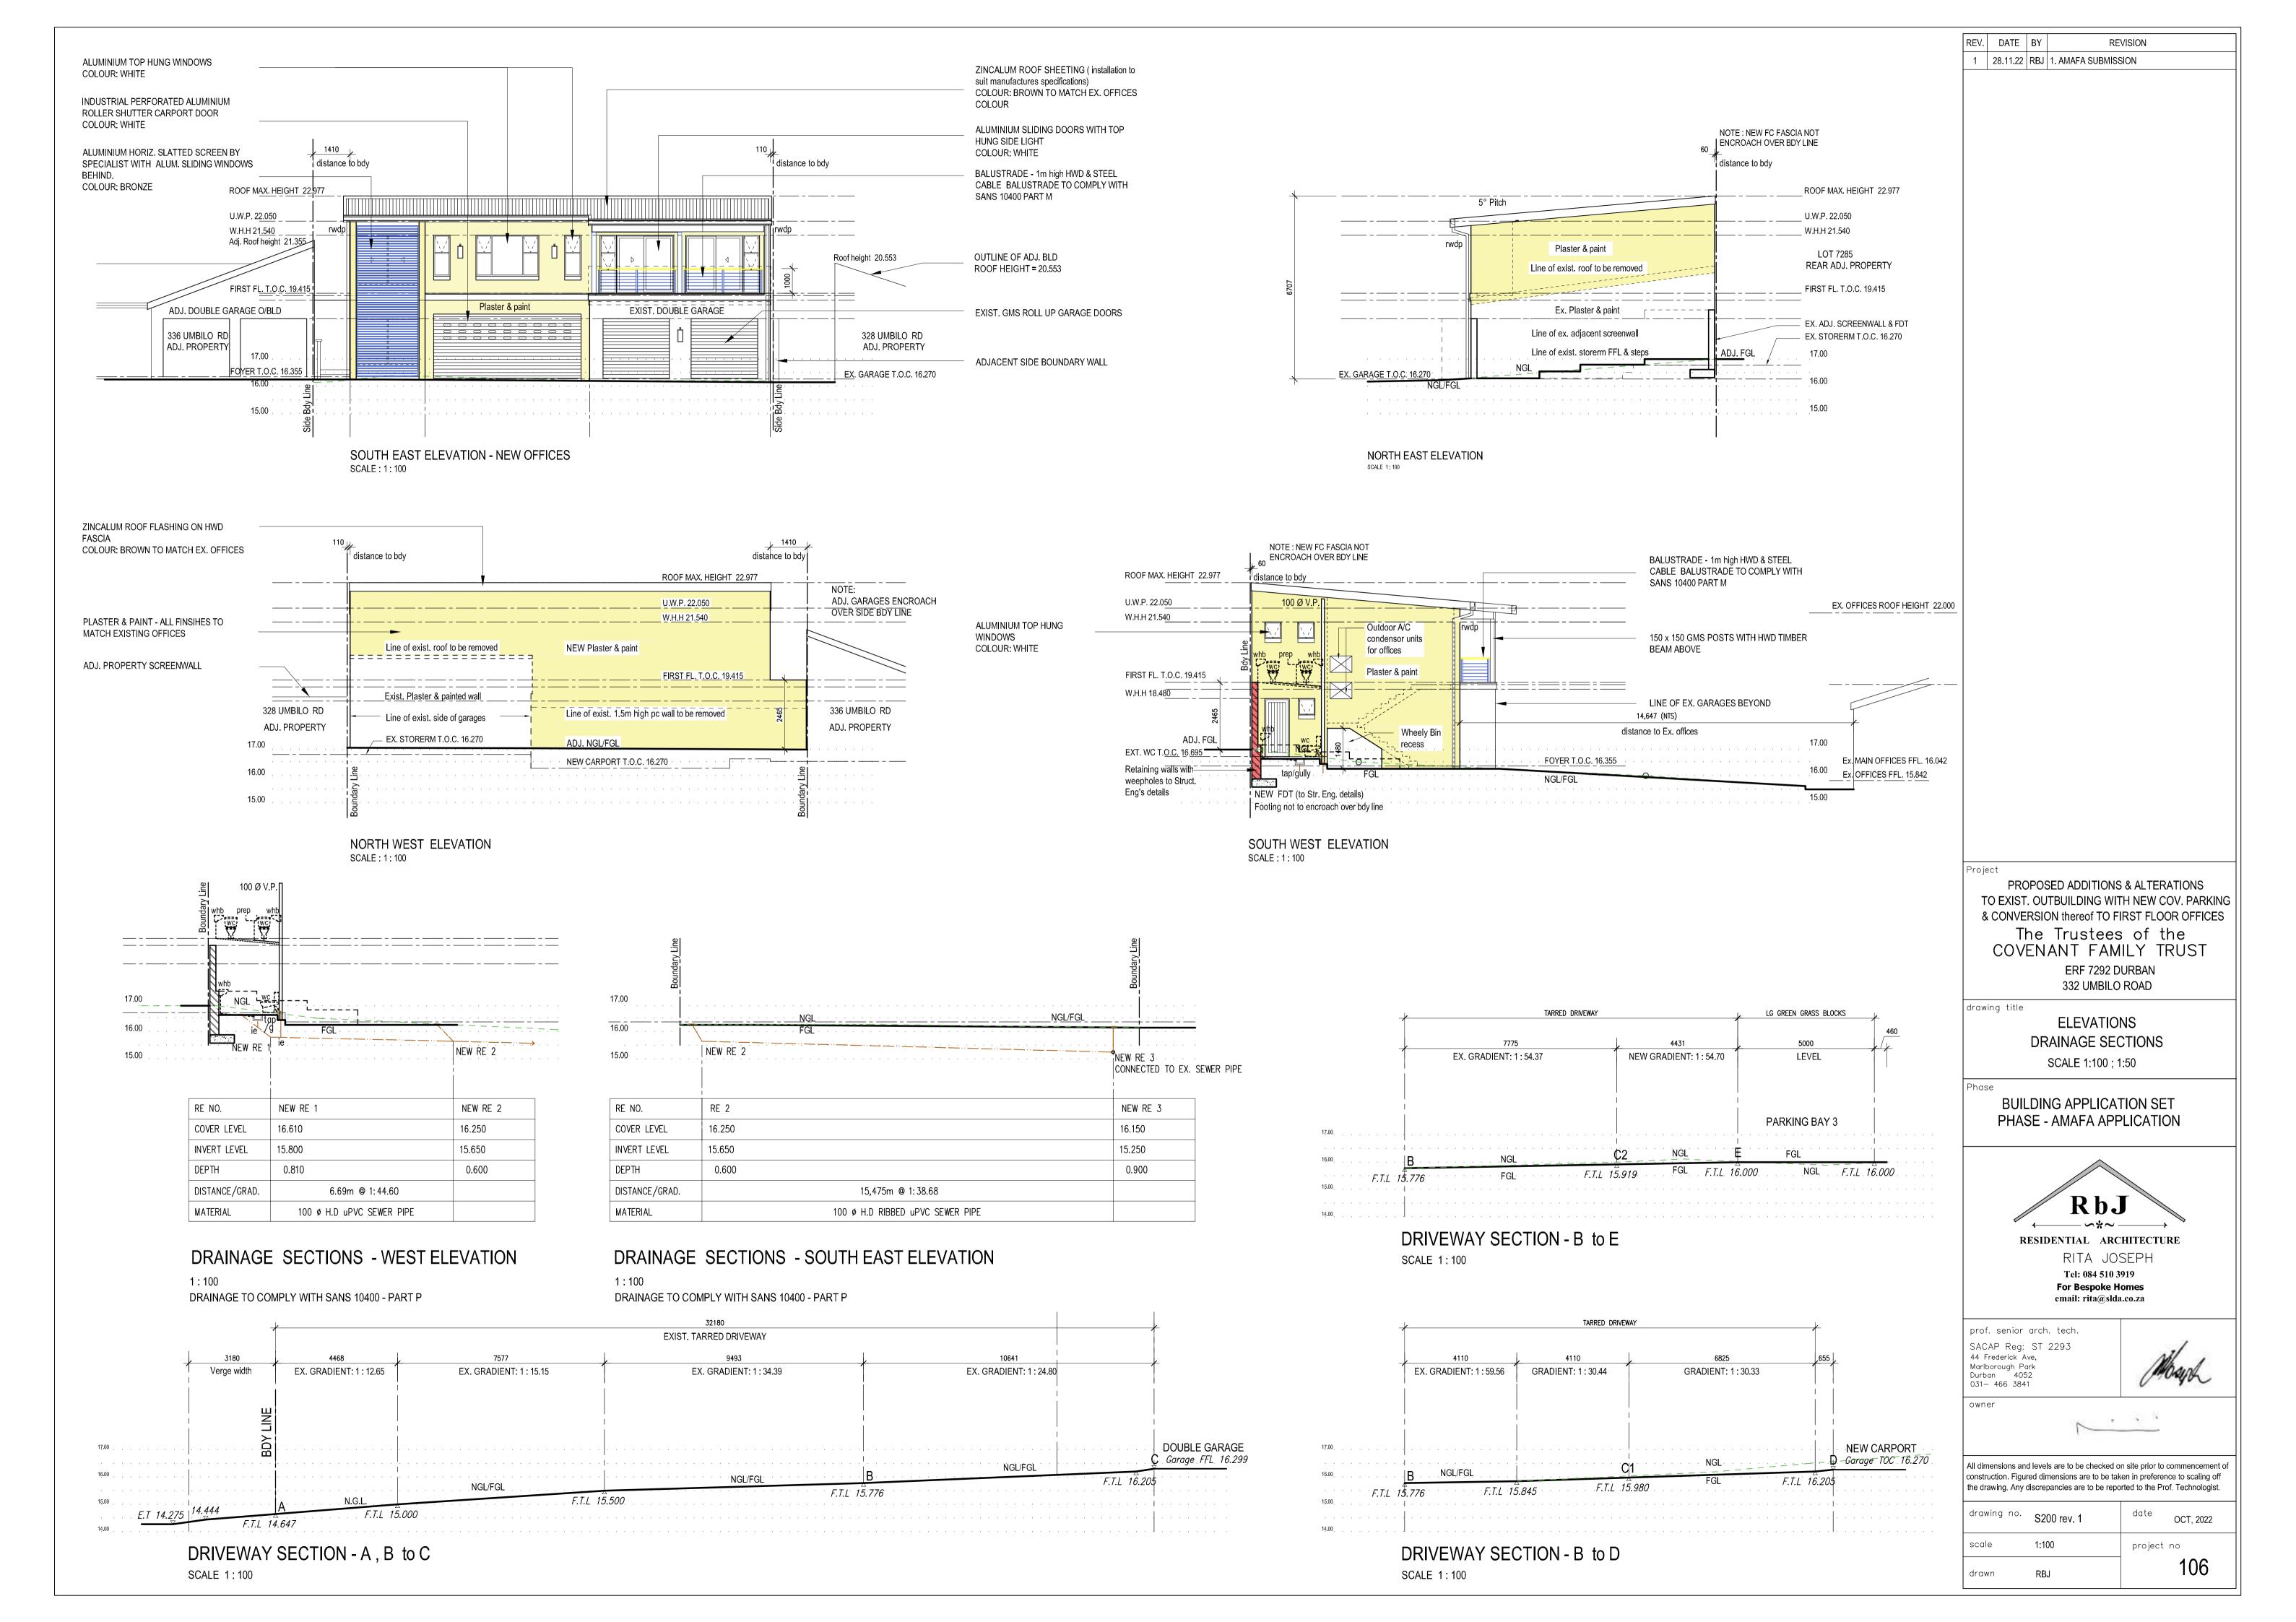SECTION A-A SCALE 1:50

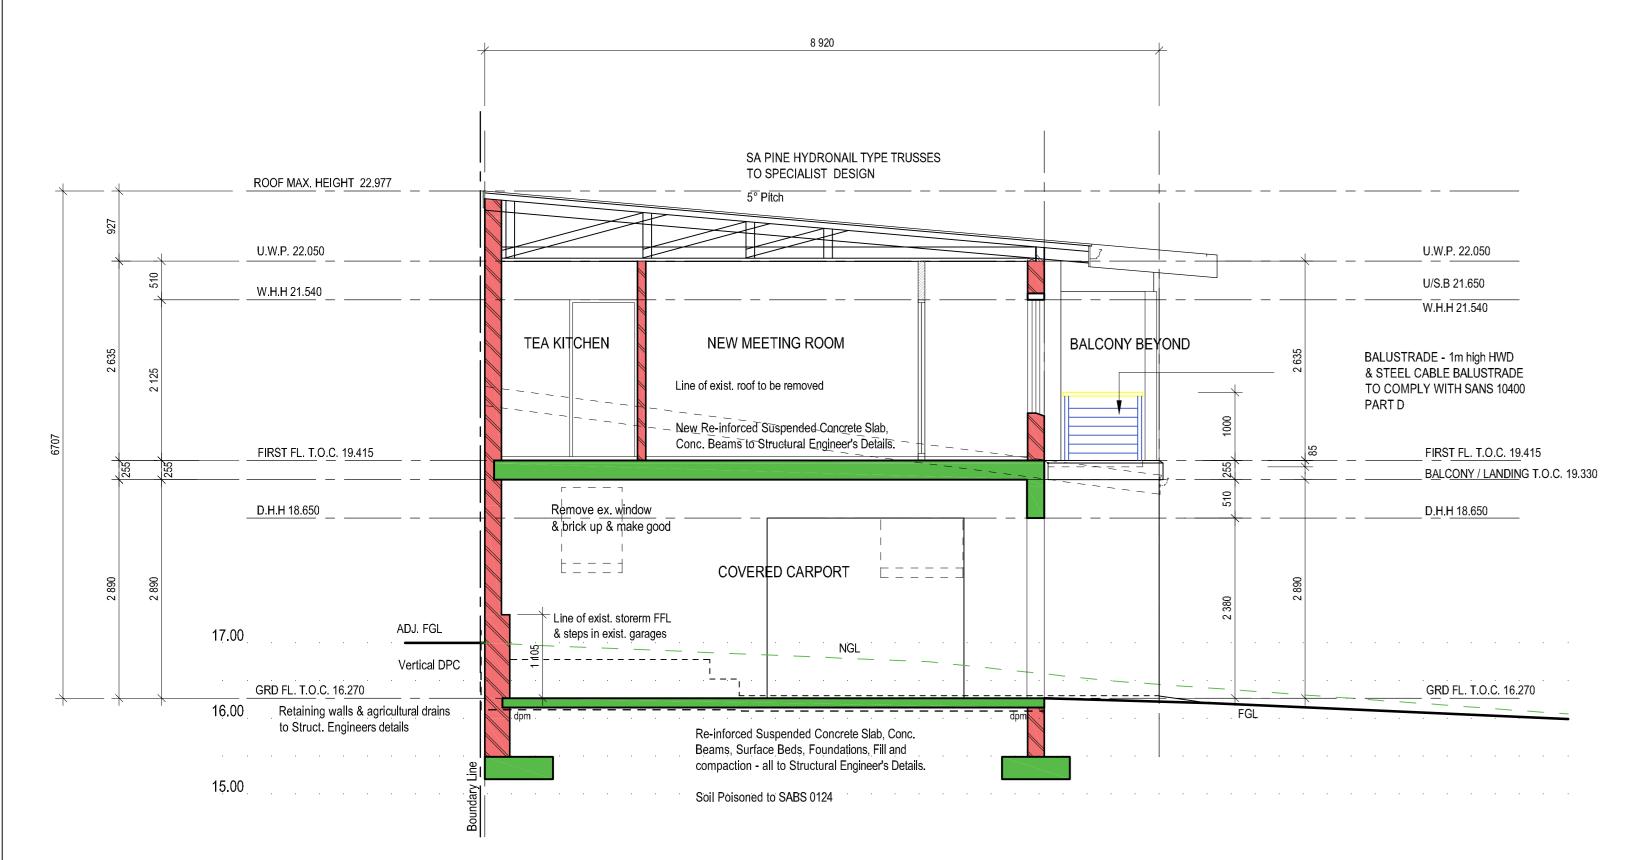

SECTION B-B SCALE 1:50

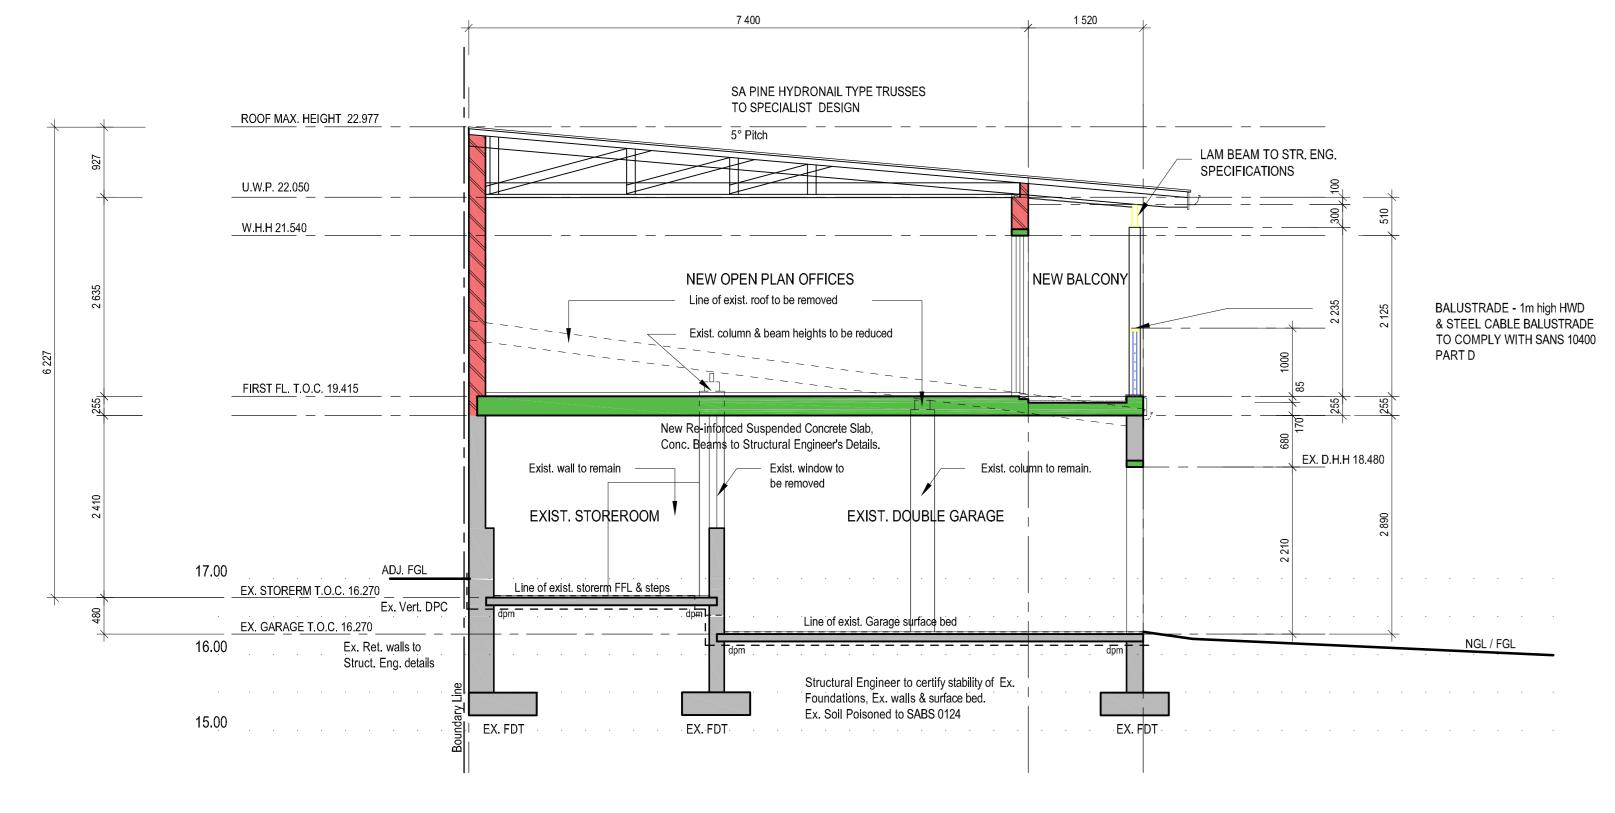


SECTION C-C


SA PINE HYDRONAIL TYPE TRUSSES TO SPECIALIST DESIGN ROOF MAX. HEIGHT 22.977 9mm RHINOBOARD CEILING 9mm RHINOBOARD CEILING ______ ___ _ _ _ _ _ _ NEW STAIRWELL NEW MEETING ROOM NEW OPEN PLAN OFFICES Dry wall partioning to comply with New Re-inforced Suspended Concrete Slab, Stairway balustrading, treads & SANS 10400 Part TT 9.1 Conc. Beams to Structural Engineer's Details. risers, All to comply with SANS -10400 part 'M' _____Line of exist. roof to be removed______ 175mm risers 275mm treads ____ ________ Plastered soffit Plastered soffit Screenwall ___ D.H.<u>H 18.650</u> __ ___ beyond Conc. beam to Eng. details Conc. beam to NEW CARPORT Eng. details -Remove window & increase opening to 3m wide - add new conc. lintols to support 17.00 brickwork above bin-recess-EX. GARAGE T.O.C. 16.270 16.00 Re-inforced Suspended Concrete Slab, Conc. Structural Engineer to certify stability of Ex. Beams, Staircase, Surface Beds, Foundations, Foundations, Ex. walls & surface bed. I NEW FDT Fill and compaction - all to Structural Engineer's Ex. Soil Poisoned to SABS 0124 15.00 FDT BEYOND NEW FDT NEW FDT EX. FDT Soil Poisoned to SABS 0124 SECTION D-D

HARDWOOD DOOR SCHEDULE **SCALE 1:50**

SCALE 1:50

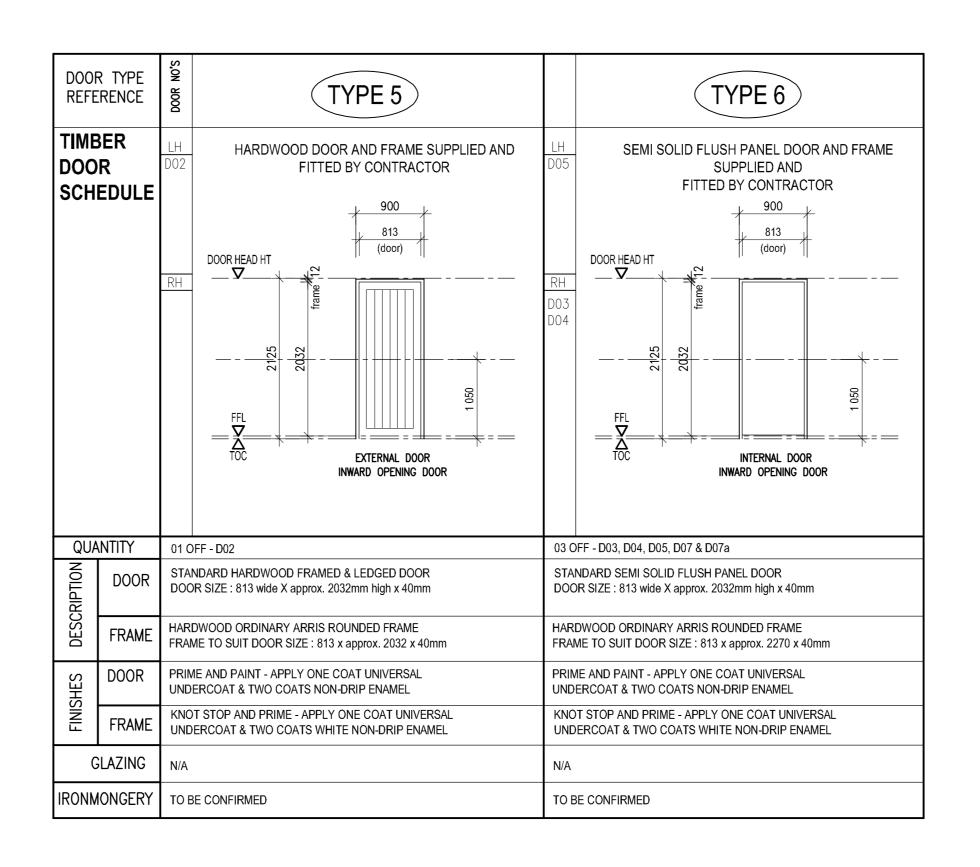

CARPORT DOOR SCHEDULE **SCALE 1:50**

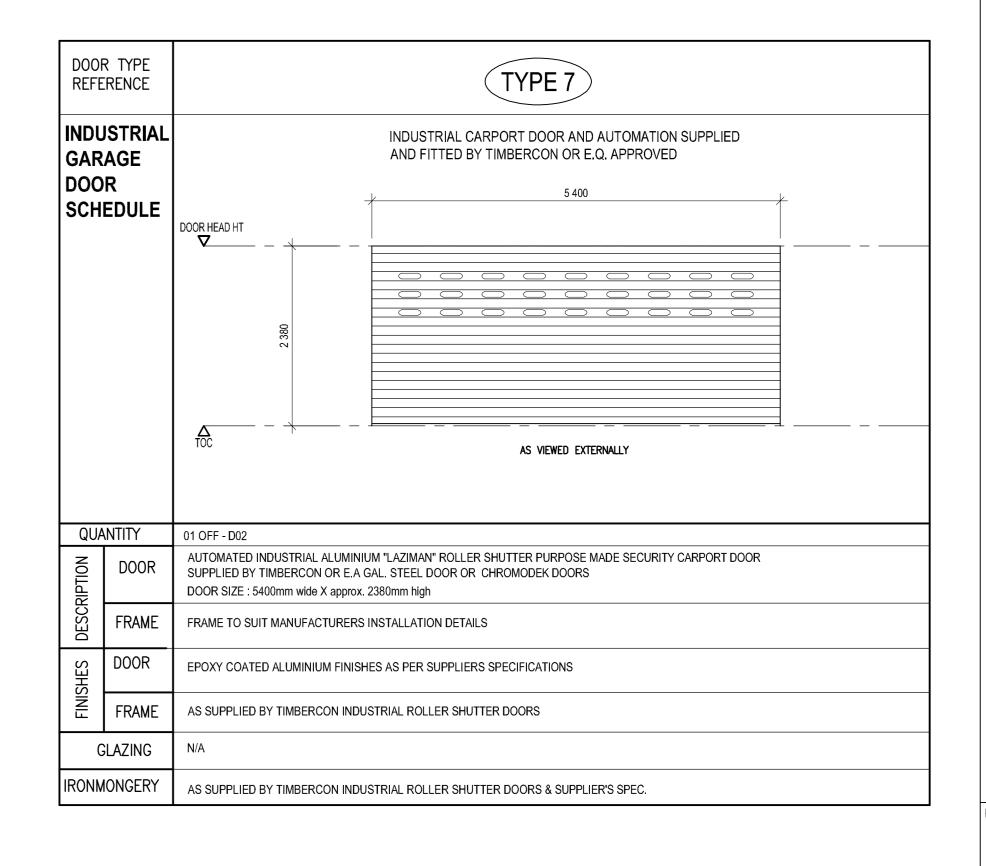

CONSTRUCTION NOTES:

ROOF CONSTRUCTION:

ZINCALUM OR EQUAL APPROVED HULETT ALUMINIUM 0.8mm GAUGE 3004 ALLOY 10/3 PROFILED ROOF SHEETING WITH BUTILE TAPE SIDE LAP SEALANT & BARGE BOARD FLASHINGS. ALL TO SABS 903-1978 ON SUPER SISALATION 405 MULTIPURPOSE UNDERLAY, ON 76x50mm SA PINE PURLINS @ MAX 800mm C/C AT EAVES AND MAX. 1000mm C/C ON INTERMEDIATE SPANS, ON UNDERLAY ON 150 x 50 mm SA PINE TREATED TRUSSES IN ACCORDANCE WITH SABS 0160-1980 AND PART ONE OF SABS 0163-1980 TIED DOWN INTO BRICKWORK TO FOUR NO. COURSES WITH GALVANISED HOOP IRONS ON OUTER EXTENTS & BALCONY WITH LAM. BEAM TO STR. ENG. SPEC'S SUPPORTED ON 150 x 150 GMS POSTS & BOLTED TO CONCRETE UPSTAND TO ENG. DETAILS. PURPOSE MADE FASCIAS & BARGEBOARDS TO SUIT FIXED TO RAFTERS & PURLINS.

75mm ISOTHERM INSULATION BLANKET IN BETWEEN RAFTER TIES.

BALCONY CEILING: 12mm CELLULOSE CEILING BOARD SKIM PLASTERED FLUSH CEILINGS ON 38x38mm BRANDERING AT CENTRES TO SUIT FITTED ON RAKE WITH 60mm STANDARD COVED CORNICE. NEW OFFICES, STAIRWELL & ABLUTIONS: SUSPENDED 9mm RHINOBOARD SKIM PLASTERED FLUSH CEILINGS ON 38 x 38mm BRANDERING AT CENTRES TO SUIT WITH MOULDED CORNICES TO OWNERS CHOICE. GROUND FLOOR CEILINGS BELOW SUSPENDED SLABS: SKIM PLASTER SLAB SOFFIT THROUGHOUT INCL. EXIST GARAGE & STORE ROOM AREA - NO CORNICES REQUIRED

EXPOSED GUTTERFAST 150x85mm PROFILED ALUMINIUM SEAMLESS GUTTERS,

BRACKETS, AND ACCESSORIES ALL TO MATCH EXISTING OFFICES. 100mm Ø uPVC RAINWATER DOWNPIPES WHERE APPLICABLE.

BRICKWORK TO BE REINFORCED WITH BRICKFORCE EVERY THREE COURSES UP TO

WINDOW HEAD AND EVERY TWO COURSES ABOVE WINDOW HEAD TO WALLPLATE LEVEL. DAMP PROOF COURSE (DPC) TO BE EMBOSSED GUNDLE BRIKGRIP 375 micron SABS 952-1969 TYPE B WELL TAPED AT ALL JOINTS AND INTERSECTIONS AND BEDDED AND JOINTED IN CEMENT MORTAR. INTERNAL WALLS TO BE FINISHED IN A THREE COAT PLASTER FINISH. ALL PLASTER TO BE APPROVED AND TESTED, PLASTER SAND WITH BLACK LABEL CEMENT AND SIKA POWDER WATERPROOFING ADD MIXTURE TO ANY EXTERIOR PLASTER BANDS IF SPECIFIED.

40-45mm TOTAL FLOOR FINISH INCLUDING SCREED ON A REINFORCED CONCRETE SURFACE BED AND FOUNDATIONS TO STRUCTURAL ENGINEERS DETAILS ON DAMP PROOF MEMBRANE (DPM) CONSISTING OF USB GREEN WATERPROOF SHEETING SABS 952.1969 TYPE C. SOIL POISIONED TO SABS 0124.

STRUCTURAL WORK

REINFORCED CONCRETE BEAMS, FOUNDATIONS, SURFACE BEDS & SUSPENDED SLABS, CONCRETE STAIRS & LANDINGS, RETAINING WALLS & AGRICULTURAL DRAINS ALL TO STRUCTURAL ENGINEERS DESIGN & SUBMITTED TO LOCAL AUTHORITY PRIOR TO COMMENCEMENT. ALL TO SABS 1200 AND PART J OF SANS 10400/1990

STAIRWAY AND BALUSTRADING STAIRWAY & BALUSTRADING, TREADS & RISERS, ALL TO COMPLY WITH SANS 10400 PART D AND

SANS 10400 PART 'M' OF THE NATIONAL BUILDING REGULATIONS

NOTE FOR EXISTING DOUBLE GARAGE STRUCTURE: COMPETENT PERSON TO INSPECT & CERTIFY ALL STRUCTURAL ASPECTS INCLUDING THE

STRUCTURAL STABILITY OF THE EXISTING GARAGES WALLS & FOUNDATIONS - ALL TO STRUCTURAL ENGINEERS DETAILED REQUIREMENTS & DESIGN.

<u>WATERPROOFIN</u>G

ONE LAYER OF 375 MICRON CONSUL PLASTICS BRIKGRIP DPC EMBOSSED DAMPPROOF COURSE UNDER WALLS AT SURFACE BED AND FLOOR LEVELS AND UNDER WINDOW CILLS. ONE LAYER OF MIN. 250 MICRON WATERPROOF SHEETING LAID UNDER SURFACE BEDS AS A DAMPPROOF MEMBRANE (DPM).

SEAL AND POINT AROUND WINDOWS AND DOORS WITH POLYSULPHIDE SEALING COMPOUND.

ALL INTERNAL WATER PIPES TO BE COPPER, EXTERNAL WATER SUPPLY TO BE POLYCOP,

SEWER PIPEWORK TO BE uPVC WITH HIGH DENSITY RIBBED uPVC UNDER SURFACE BEDS,

STORMWATER CONTROL STORMWATER CONTROL & ATTENTUATION TANK TO STRUCTURAL ENGINEERS DETAILS SUBMITTED TO LOCAL AUTHORITY PRIOR TO COMMENCEMENT

<u>PLUMBING</u>

FOUNDATIONS AND DRIVEWAYS. NO SEWER JUNCTION PERMITTED BELOW A CONCEALED FLOOR SLAB. IE'S AT ALL JUNCTIONS BELOW SUSPENDED SLABS FOR NEW MES AND SEPERATE WC - ALL CONCEALED BY NEW SUSPENDED CEILING (REFER TO SECTION C-C) ALL SEWER VENT PIPES TO BE CONCEALED WITH ACCESS PANELS WHERE APPLICABLE AS NOTED...

OCCUPANCY CLASSIFICATION G1 - OFFICES

WATER AND SANITARY PIPEWORK

CONCEALED PVC GULLIES TO LOCAL AUTHORITY APPROVAL ALL WATER AND SANITARY PIPEWORK ABOVE GROUND TO BE HIDDEN AS FAR AS POSSIBLE, OR POSITIONED BY THE PLUMBER IN SUCH A MANNER THAT THE ELEVATIONS ARE NOT SPOILT, EXPOSED PIPEWORK TO BE KEPT TO A MINIMUM, AND WHERE EXPOSED MUST BE PAINTED TO TO MATCH EXISTING WALL SURFACE. THE USE OF STUB STACKS AND LOW LEVEL VENT VALVES ARE ENCOURAGED. SEWER AND STORMWATER CONNECTIONS TO BE CARRIED OUT IN STRICT ACCORDANCE WITH PART P & R OF SABS 0400-1990. SEWER AND STORMWATER CONNECTIONS TO BE EXPOSED BY THE CONTRACTOR AND TO BE

SOIL CONDITIONS:

GEOTECH ENGINEERS TO PROVIDE GEOTECH REPORT AFTER SITE INVESTIGATIONS & TEST PITS HAVE BEEN CONDUCTED.

VERIFIED BY THE DISTRICT BUILDING INSPECTOR PRIOR TO DRAINAGE WORK COMMENCING ON SITE.

ALL LEVELS & DIMENSIONS TO BE CHECKED PRIOR TO COMMENCEMENT. ANY DISCREPANCIES TO BE BROUGHT TO THE ATTENTION OF THE PROF. TECHNOLOGIST IN ORDER THAT CORRECTIONS CAN BE MADE IF NECESSARY.

ALL WORKMANSHIP, INSTALLATION AND FINISHING PROCEDURES FOR CONCRETE, ALUMINIUM, PVC, MASONRY AND TIMBER MUST BE DONE IN ACCORDANCE WITH SABS CODES OF PRACTICE AND STANDARD PREAMBLE FOR WORKS.

FLOORS TO COMPLY WITH SANS 10400/1990 - PART J WALLS TO COMPLY WITH SANS 10400/1990 - PART K ROOF TO COMPLY WITH SANS 10400/1990 - PART L STAIRS TO COMPLY WITH SANS 10400/1990 - PART M BALUSTRADING TO COMPLY WITH SANS 10400/1990 - PART MM3 RETAINING WALLS TO COMPLY WITH SANS 10400/1990 - PART DD.2 GLAZING TO COMPLY WITH SANS 10400/1990 - PART N DRAINAGE TO COMPLY WITH SANS 10400-1990 -PART P STORMWATER TO COMPLY WITH SANS 10400/1990 - PART R NATURAL LIGHTING TO COMPLY WITH SANS 10400-1990 -PART O (MIN. 10% OF FLOOR AREA)

FIRE PLANS - REFER TO DRAWINGS S 600 rev. 1 & S 601-rev. 1

PROPOSED ADDITIONS & ALTERATIONS TO EXIST. OUTBUILDING WITH NEW COV. PARKING & CONVERSION thereof TO FIRST FLOOR OFFICES The Trustees of the COVENANT FAMILY TRUST ERF 7292 DURBAN 332 UMBILO ROAD

drawing title SECTIONS A-A; B-B; C-C & D-D HARDWOOD & GARAGE DOOR SCHEDULE

REV. DATE BY

28.11.22 RBJ 1. AMAFA SUBMISSION


BUILDING APPLICATION SET PHASE - AMAFA APPLICATION

SCALE 1:50



email: rita@slda.co.za


prof. senior arch. tech. SACAP Reg: ST 2293 44 Frederick Ave, Marlborough Park Durban 4052 031- 466 3841

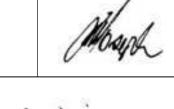


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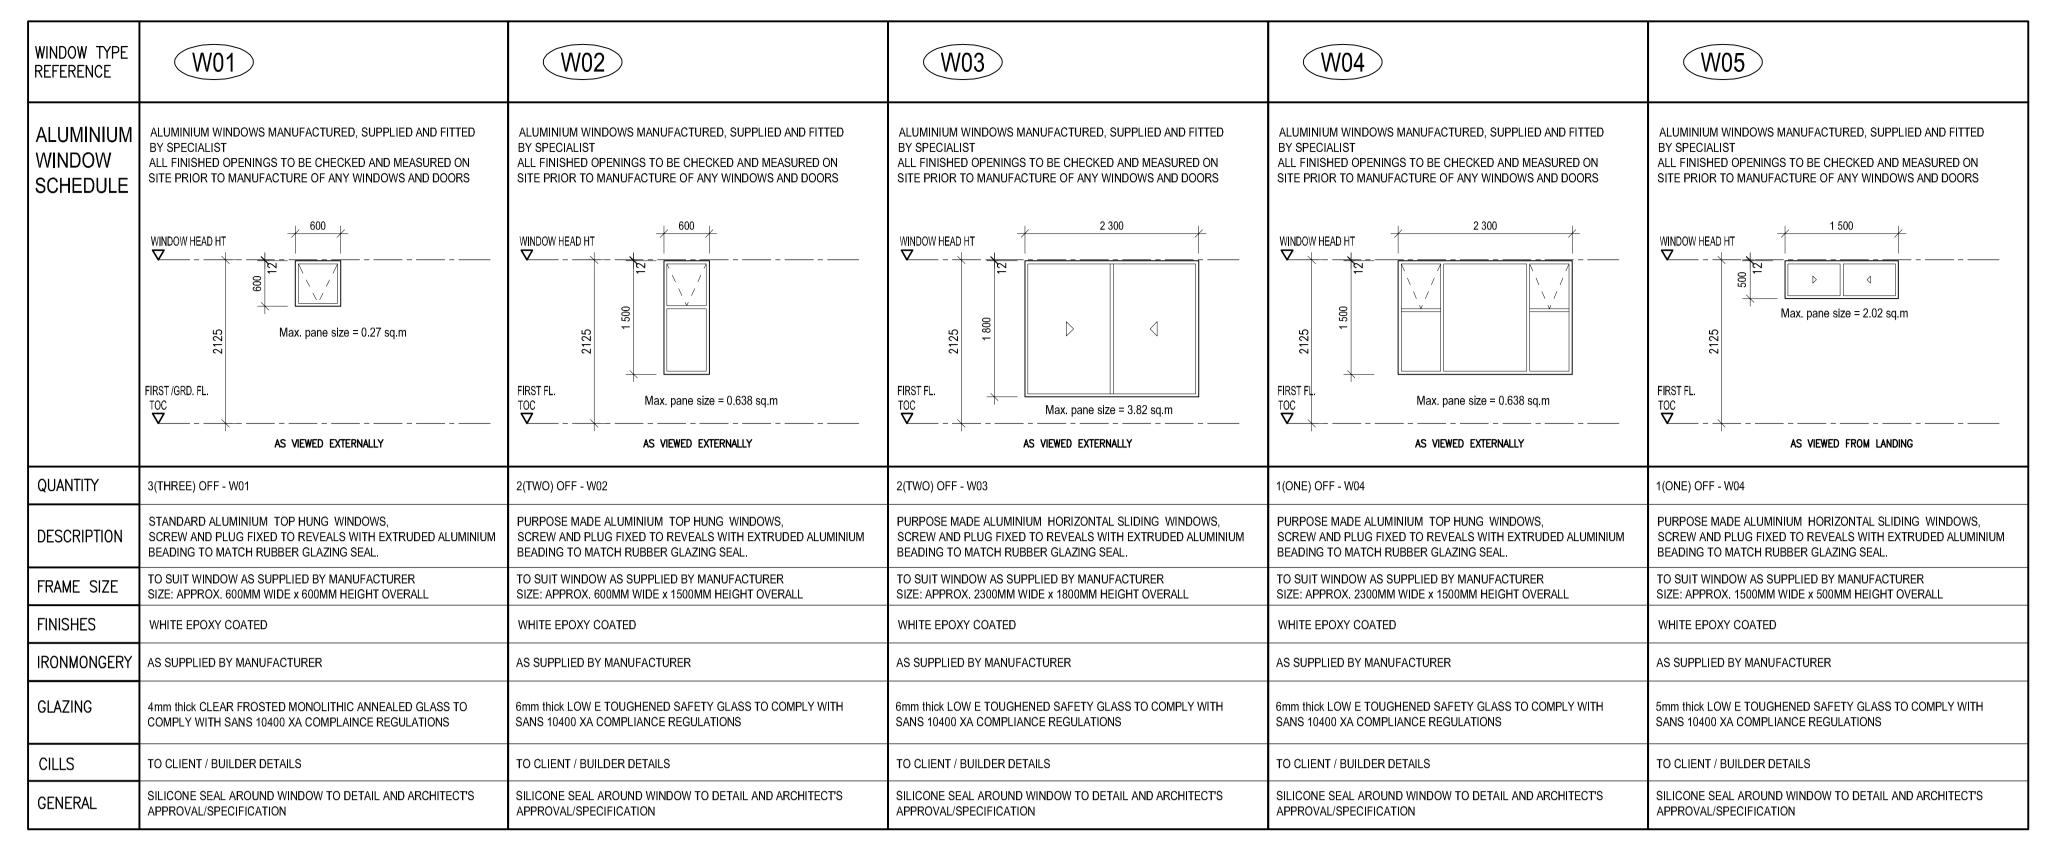
drawing no. S300 rev. 1 scale 1:50 project no drawn






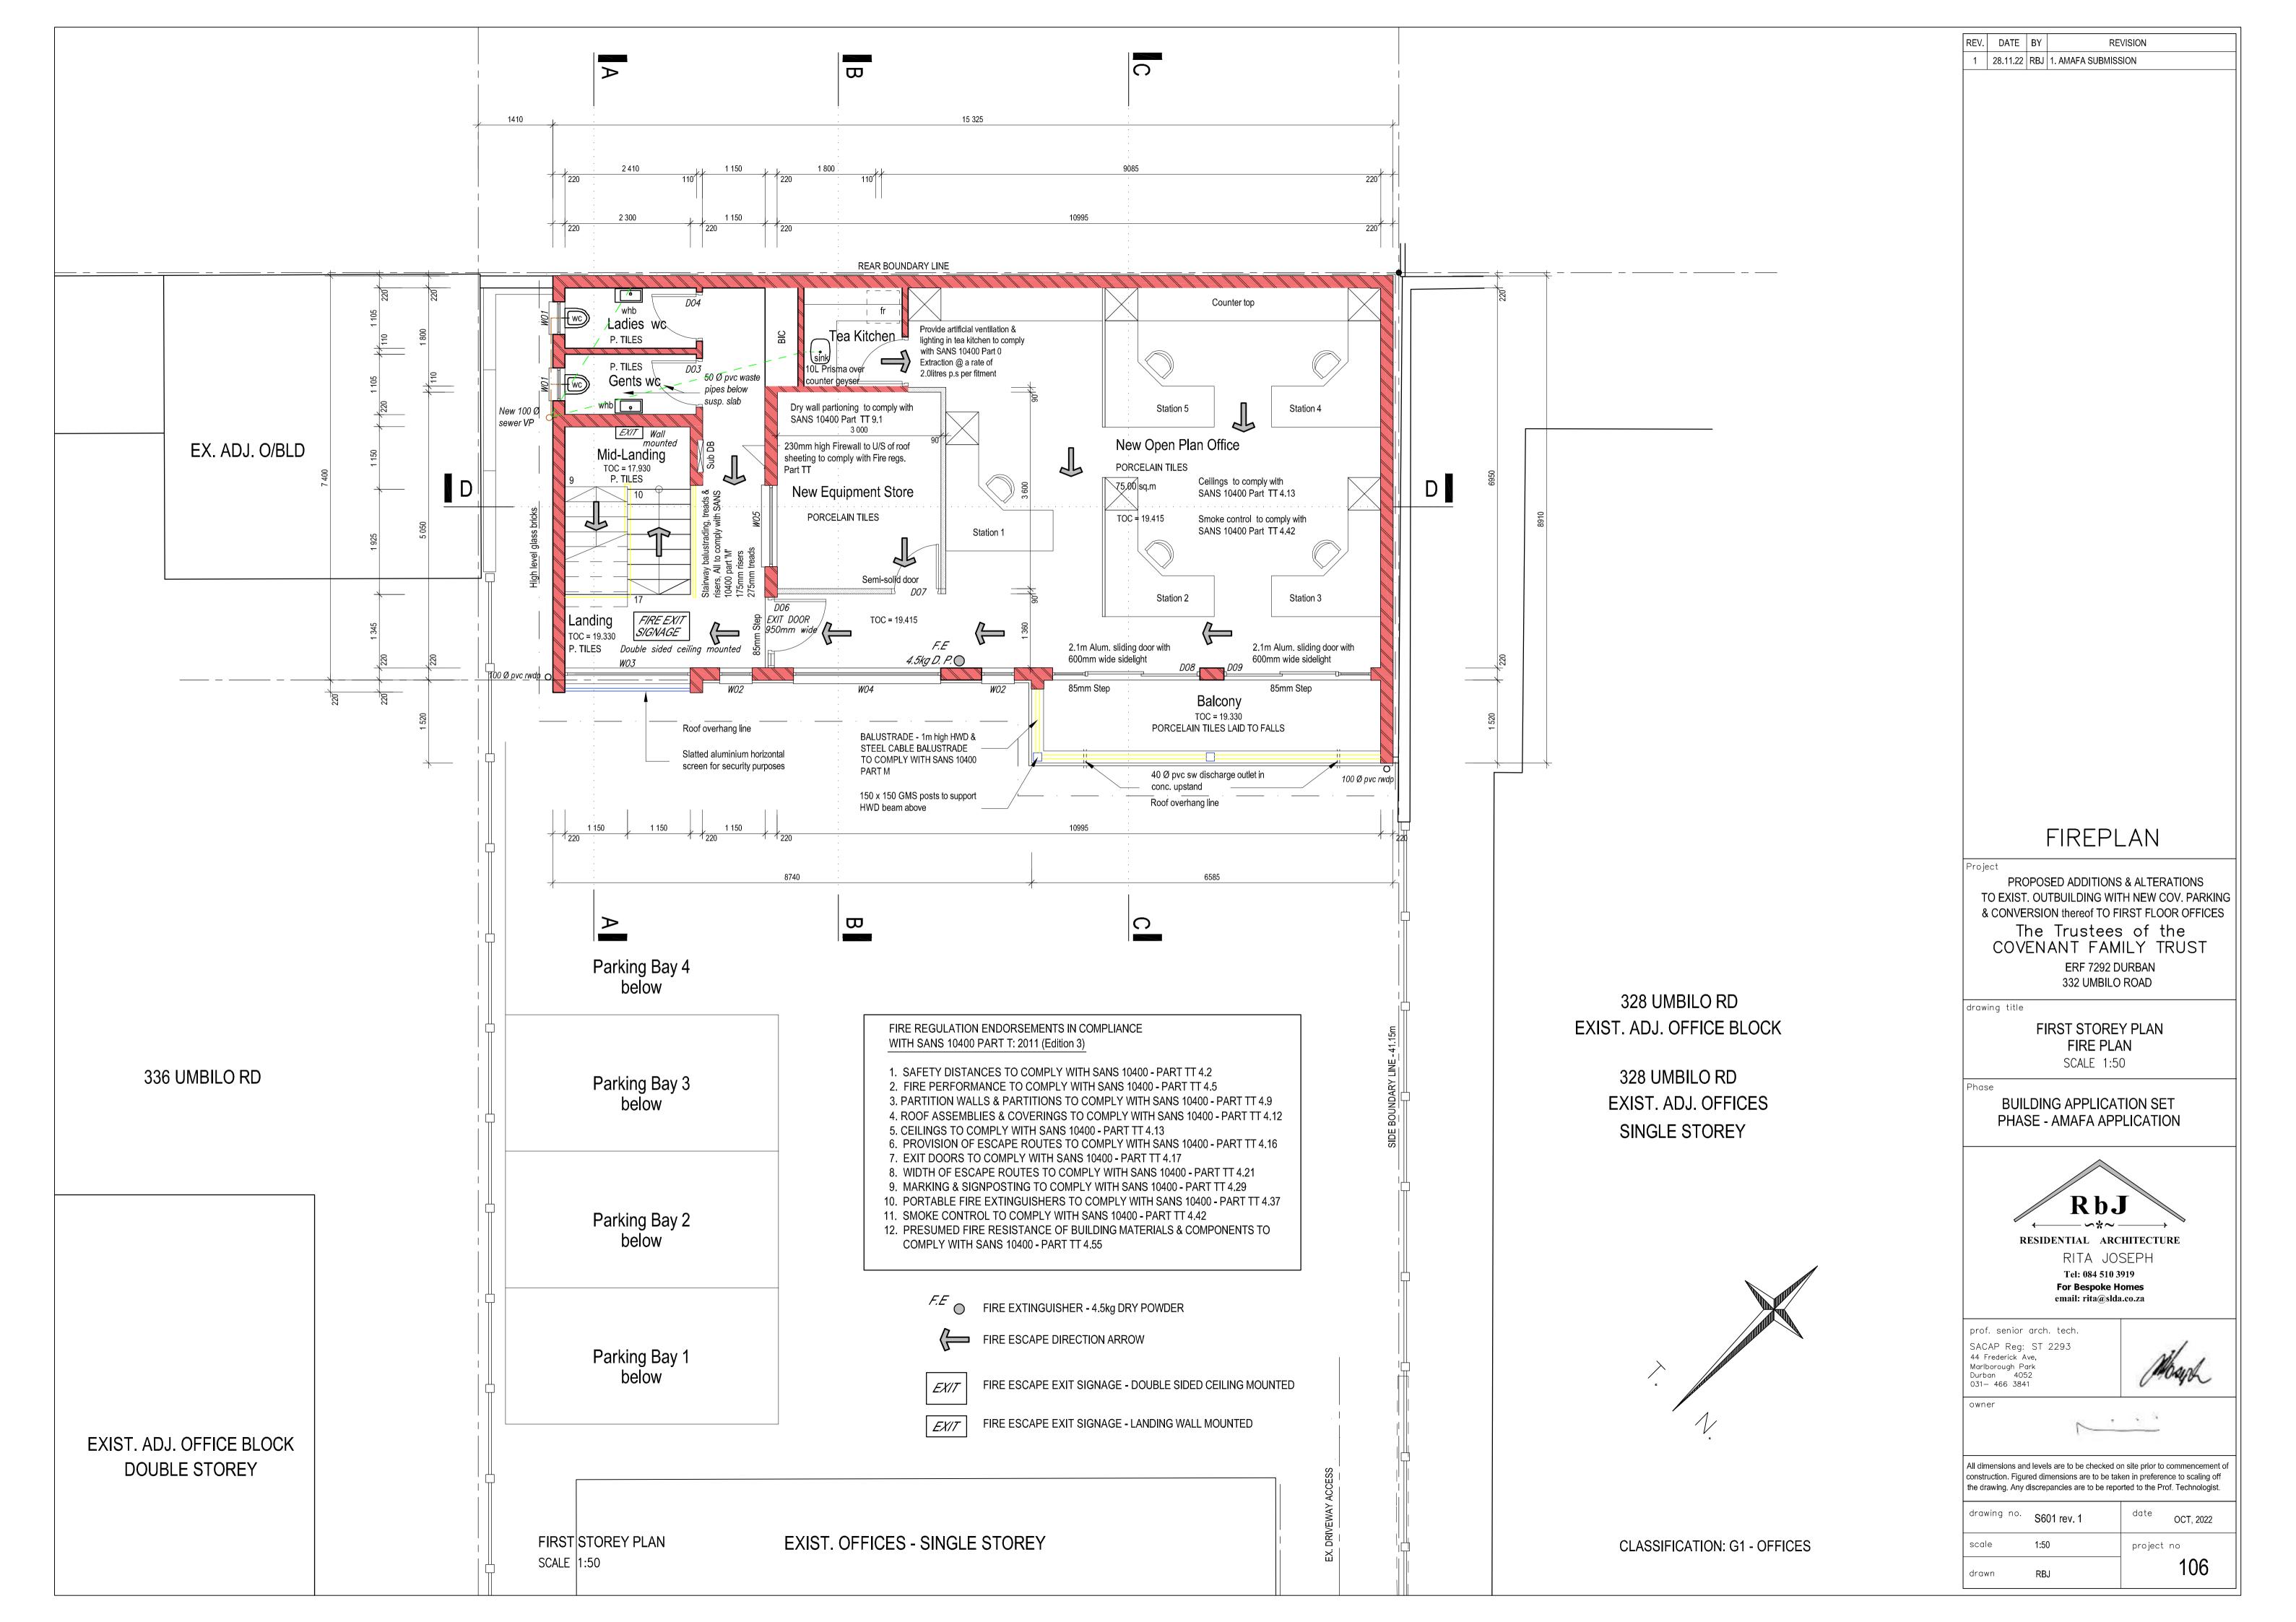

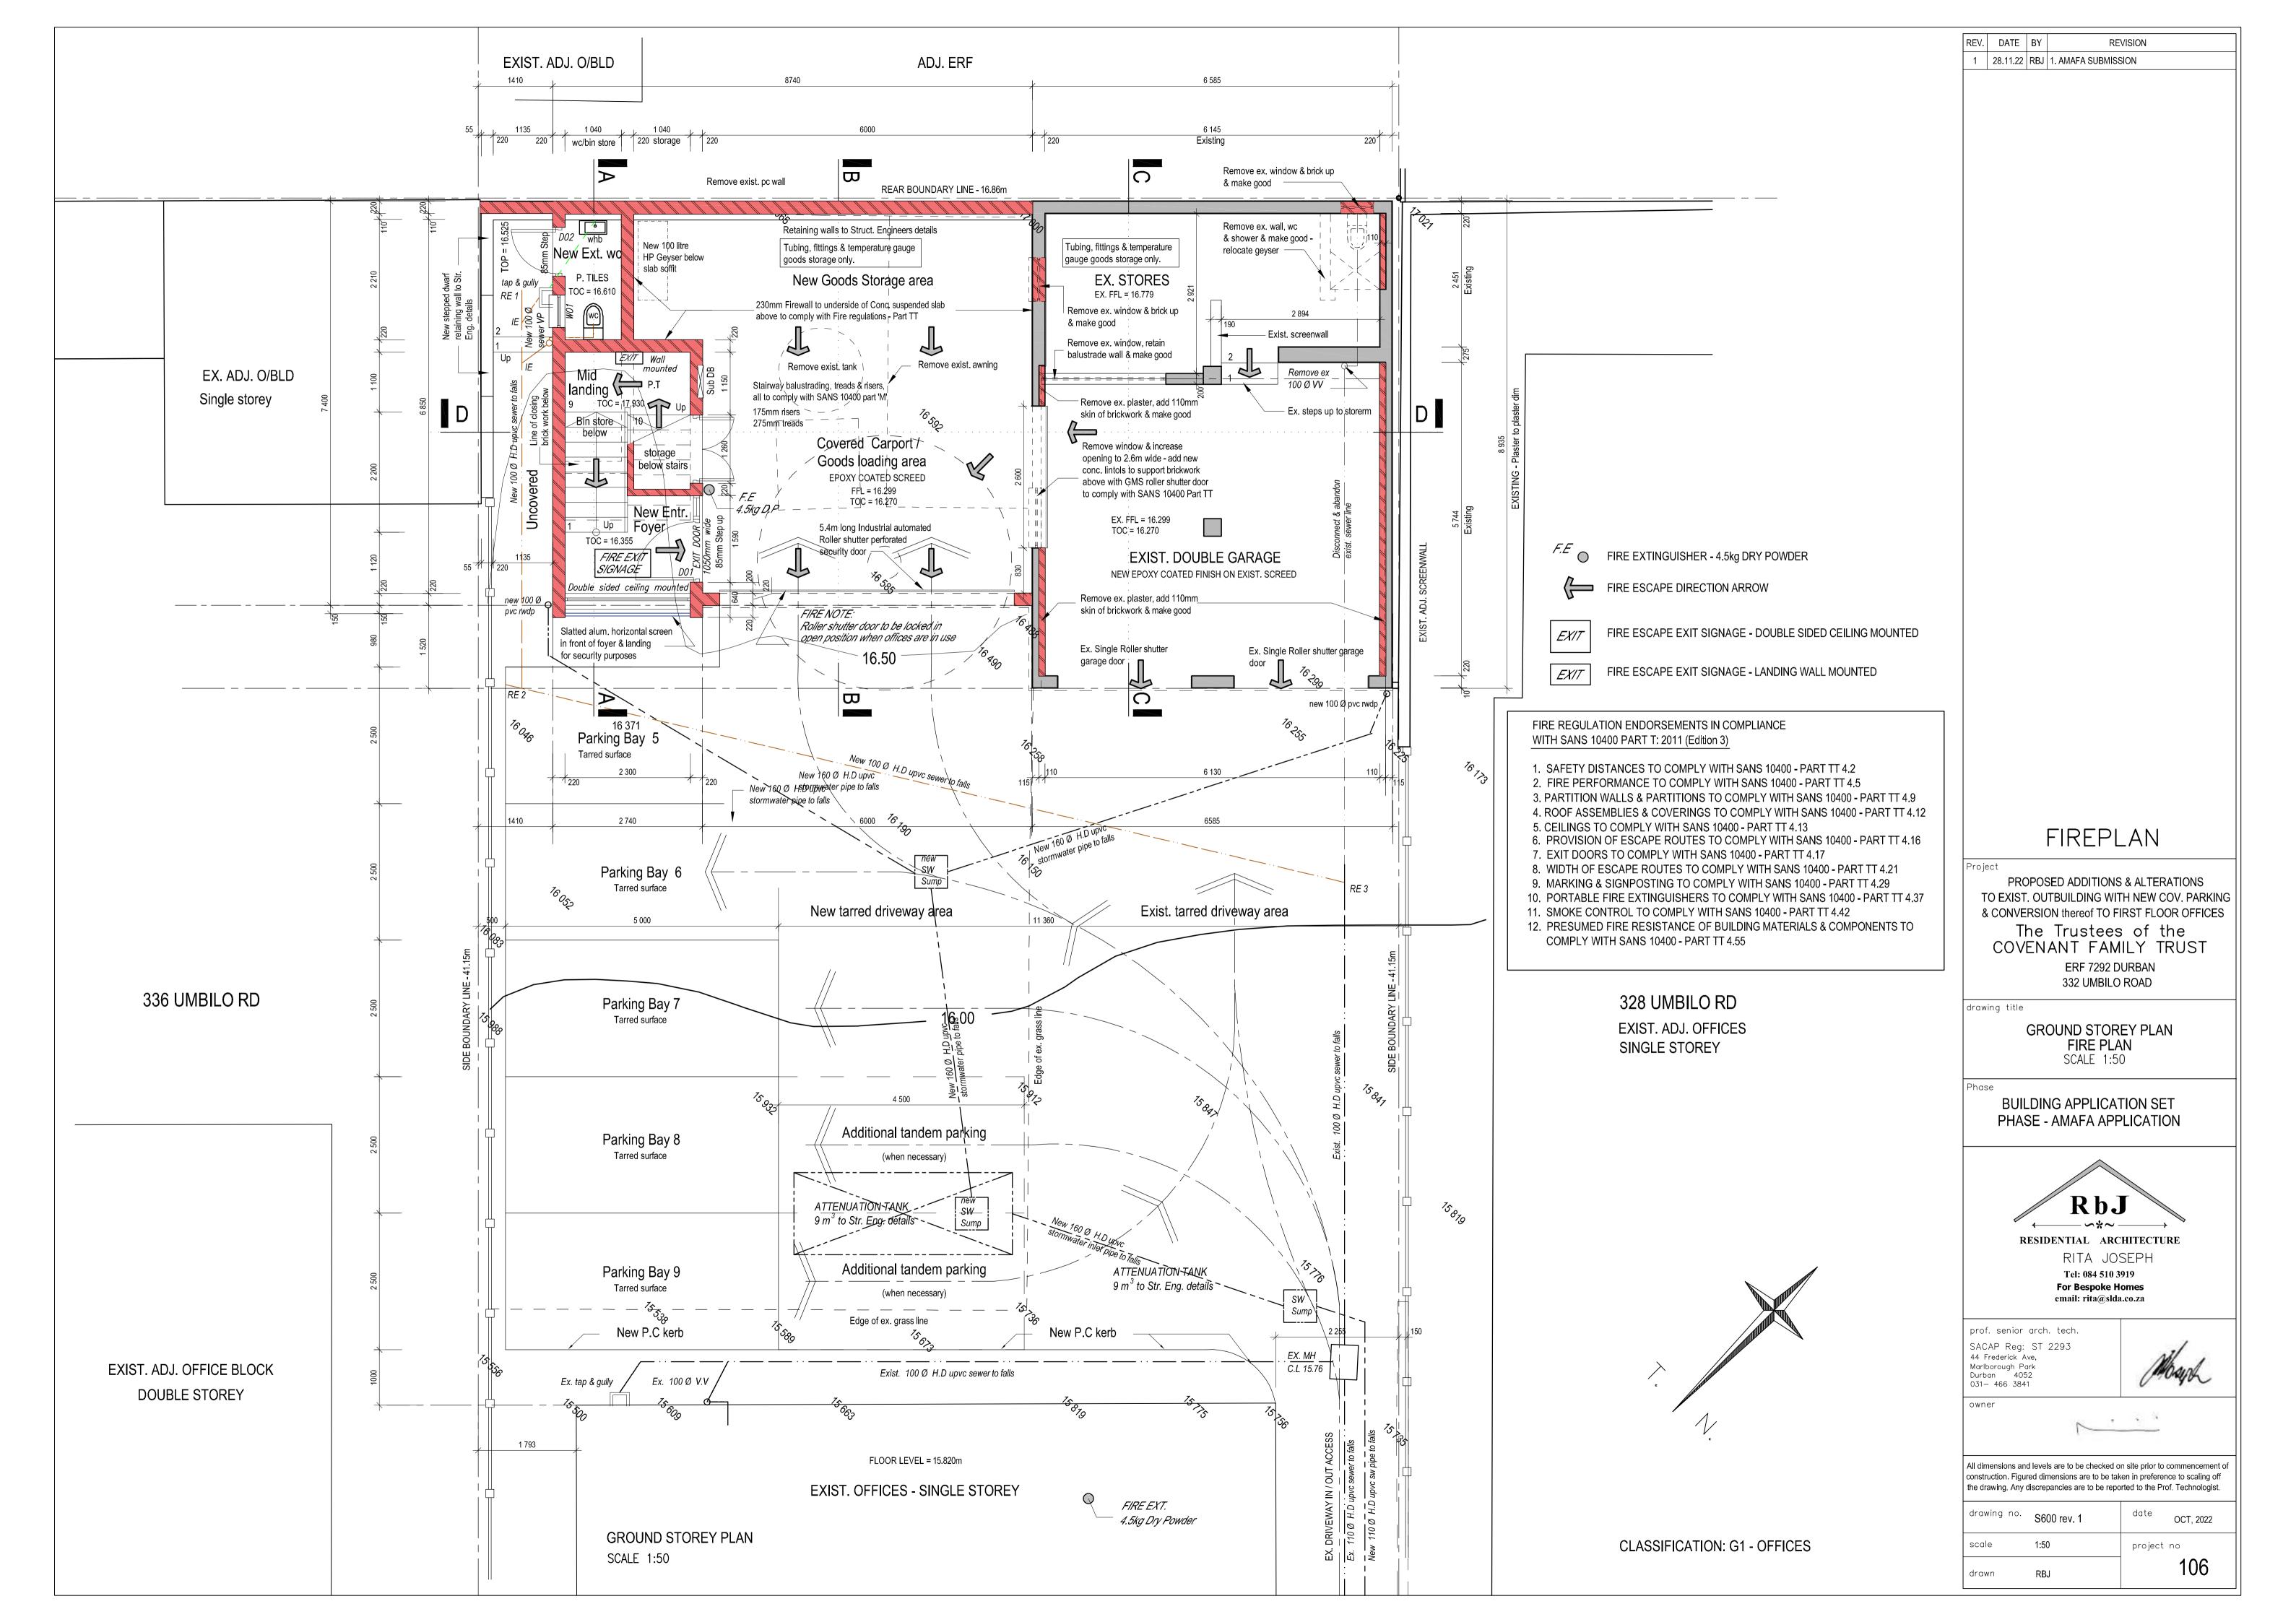ALUMINUIM WINDOW SCHEDULE - SCALE 1:50



ALUM. SLIDING DOOR SCHED. SCALE 1:50

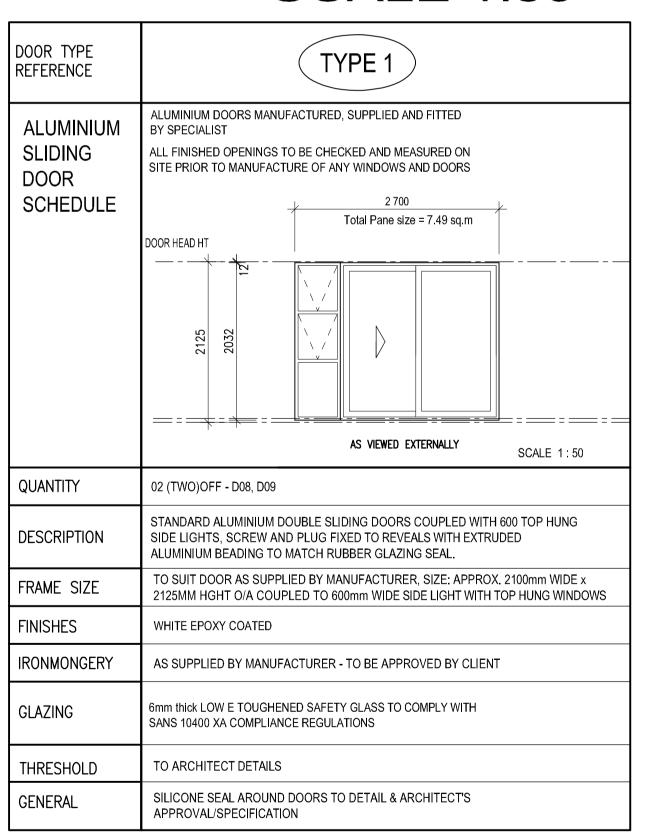

NOTES FOR SANS 10400 PART XA

NOTE: OFFICES AIRCONDITIONED WITH MID-WALL SPLIT UNITS

ALL WINDOWS / SLIDING DOORS AND INSTALLATION TO COMPLY WITH SANS 10400 AND NBR

ALL WINDOWS TO BE SABS APPROVED

WINDOW MANUFACTURER TO ISSUE COMPLIANCE CERTIFICATE

WINDOW/SLIDING DOOR MANUFACTURE AND INSTALLER TO ENSURE THAT AIR LEAKAGE REQUIREMENTS

COMPLY WITH SANS 10400 PART XA AND NBR

ALL FENESTRATION SHALL BE IN ACCORDANCE WITH SANS 613 WHICH PROVIDES FOR FENESTRATION PRODUCTS TO MEET A MINIMUM AIR LEAKAGE REQUIREMENT OF 2.0L/m/s MANUFACTURES TO SUPPLY CERTIFICATION

NOTE:

ALL BRICK OPENING SIZES FOR DOORS TO BE SPECIFIED BY THE APPOINTED JOINERY SPECIALIST TO SUIT DOOR & FRAME DETAILS APPROVED BY THE CONTRACTOR / OWNER

ALUM. SINGLE DOOR SCHEDULE. SCALE 1:50

TYPE 2	TYPE 3
ALUMINIUM DOORS MANUFACTURED, SUPPLIED AND FITTED BY SPECIALIST ALL FINISHED OPENINGS TO BE CHECKED AND MEASURED ON SITE PRIOR TO MANUFACTURE OF ANY WINDOWS AND DOORS 1590 Total Pane size = 7.49 sq.m 1060 door AS VIEWED EXTERNALLY	ALUMINIUM DOORS MANUFACTURED, SUPPLIED AND FITTED BY SPECIALIST ALL FINISHED OPENINGS TO BE CHECKED AND MEASURED ON SITE PRIOR TO MANUFACTURE OF ANY WINDOWS AND DOORS Total Pane size = 7.49 sq.m 950 door AS VIEWED FROM LANDING
01 (ONE)OFF - D01	01 (ONE)OFF - D06
PURPOSE MADE ALUM. EXTRA WIDE SINGLE DOOR WITH SIDELIGHT, SCREW AND PLUG FIXED TO REVEALS WITH EXTRUDED ALUMINIUM BEADING TO MATCH RUBBER GLAZING SEAL.	PURPOSE MADE ALUM. EXTRA WIDE SINGLE DOOR WITH SIDELIGHT, SCREW AND PLUG FIXED TO REVEALS WITH EXTRUDED ALUMINIUM BEADING TO MATCH RUBBER GLAZING SEAL.
TO SUIT DOOR & SIDE LIGHT AS SUPPLIED BY MANUFACTURER SIZE: OVERLL 1590MM WIDE x 2125MM HEIGHT OVERALL	TO SUIT DOOR & SIDE LIGHT AS SUPPLIED BY MANUFACTURER SIZE: OVERLL 1300MM WIDE x 2125MM HEIGHT OVERALL
WHITE EPOXY COATED	WHITE EPOXY COATED
AS SUPPLIED BY MANUFACTURER - TO BE APPROVED BY CLIENT	AS SUPPLIED BY MANUFACTURER - TO BE APPROVED BY CLIENT
6mm thick LOW E TOUGHENED SAFETY GLASS TO COMPLY WITH SANS 10400 XA COMPLIANCE REGULATIONS	6mm thick LOW E TOUGHENED SAFETY GLASS TO COMPLY WITH SANS 10400 XA COMPLIANCE REGULATIONS
TO ARCHITECT DETAILS	TO ARCHITECT DETAILS
SILICONE SEAL AROUND DOORS TO DETAIL & ARCHITECT'S APPROVAL/SPECIFICATION	SILICONE SEAL AROUND DOORS TO DETAIL & ARCHITECT'S APPROVAL/SPECIFICATION
	ALUMINIUM DOORS MANUFACTURED, SUPPLIED AND FITTED BY SPECIALIST ALL FINISHED OPENINGS TO BE CHECKED AND MEASURED ON SITE PRIOR TO MANUFACTURE OF ANY WINDOWS AND DOORS 1 590 Total Pane size = 7.49 sqm 1 060 door PURPOSE MADE ALUM. EXTRA WIDE SINGLE DOOR WITH SIDELIGHT, SCREW AND PLUG FIXED TO REVEALS WITH EXTRUDED ALUMINIUM BEADING TO MATCH RUBBER GLAZING SEAL. TO SUIT DOOR & SIDE LIGHT AS SUPPLIED BY MANUFACTURER SIZE: OVERLL 1590MM WIDE x 2125MM HEIGHT OVERALL WHITE EPOXY COATED AS SUPPLIED BY MANUFACTURER - TO BE APPROVED BY CLIENT 6mm thick LOW E TOUGHENED SAFETY GLASS TO COMPLY WITH SANS 10400 XA COMPLIANCE REGULATIONS TO ARCHITECT DETAILS SILICONE SEAL AROUND DOORS TO DETAIL & ARCHITECT'S

NOTE: ALL BRICK OPENINGS TO BE CHECKED ON SITE PRIOR TO MANUFACTURE OF ANY ALUMINIUM OR HARDWOOD WINDOWS & DOORS

OCCUPANCY CLASSIFICATION - G1 - OFFICES GLAZING AREA CALCULATIONS REFER TO XA CALCULATIONS DOCUMENT.

REV.	DATE	BY	REVISION
1	02.11.22	RBJ	1. AMAFA SUBMISSION

PROPOSED ADDITIONS & ALTERATIONS
TO EXIST. OUTBUILDING WITH NEW COV. PARKING
& CONVERSION thereof TO FIRST FLOOR OFFICES
The Trustees of the
COVENANT FAMILY TRUST

ERF 7292 DURBAN

drawing title

ALUMINIUM WINDOW & DOOR SCHEDULESCALE 1:50

332 UMBILO ROAD

Phase

BUILDING APPLICATION SET PHASE - AMAFA APPLICATION



email: rita@slda.co.za

prof. senior arch. tech.
SACAP Reg: ST 2293
44 Frederick Ave,
Marlborough Park
Durban 4052
031- 466 3841



owner

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S400 rev. 1	OCT, 2022
scale 1:50	project no
drawn RBJ	106