






SAIBD L0519/2021/KZN

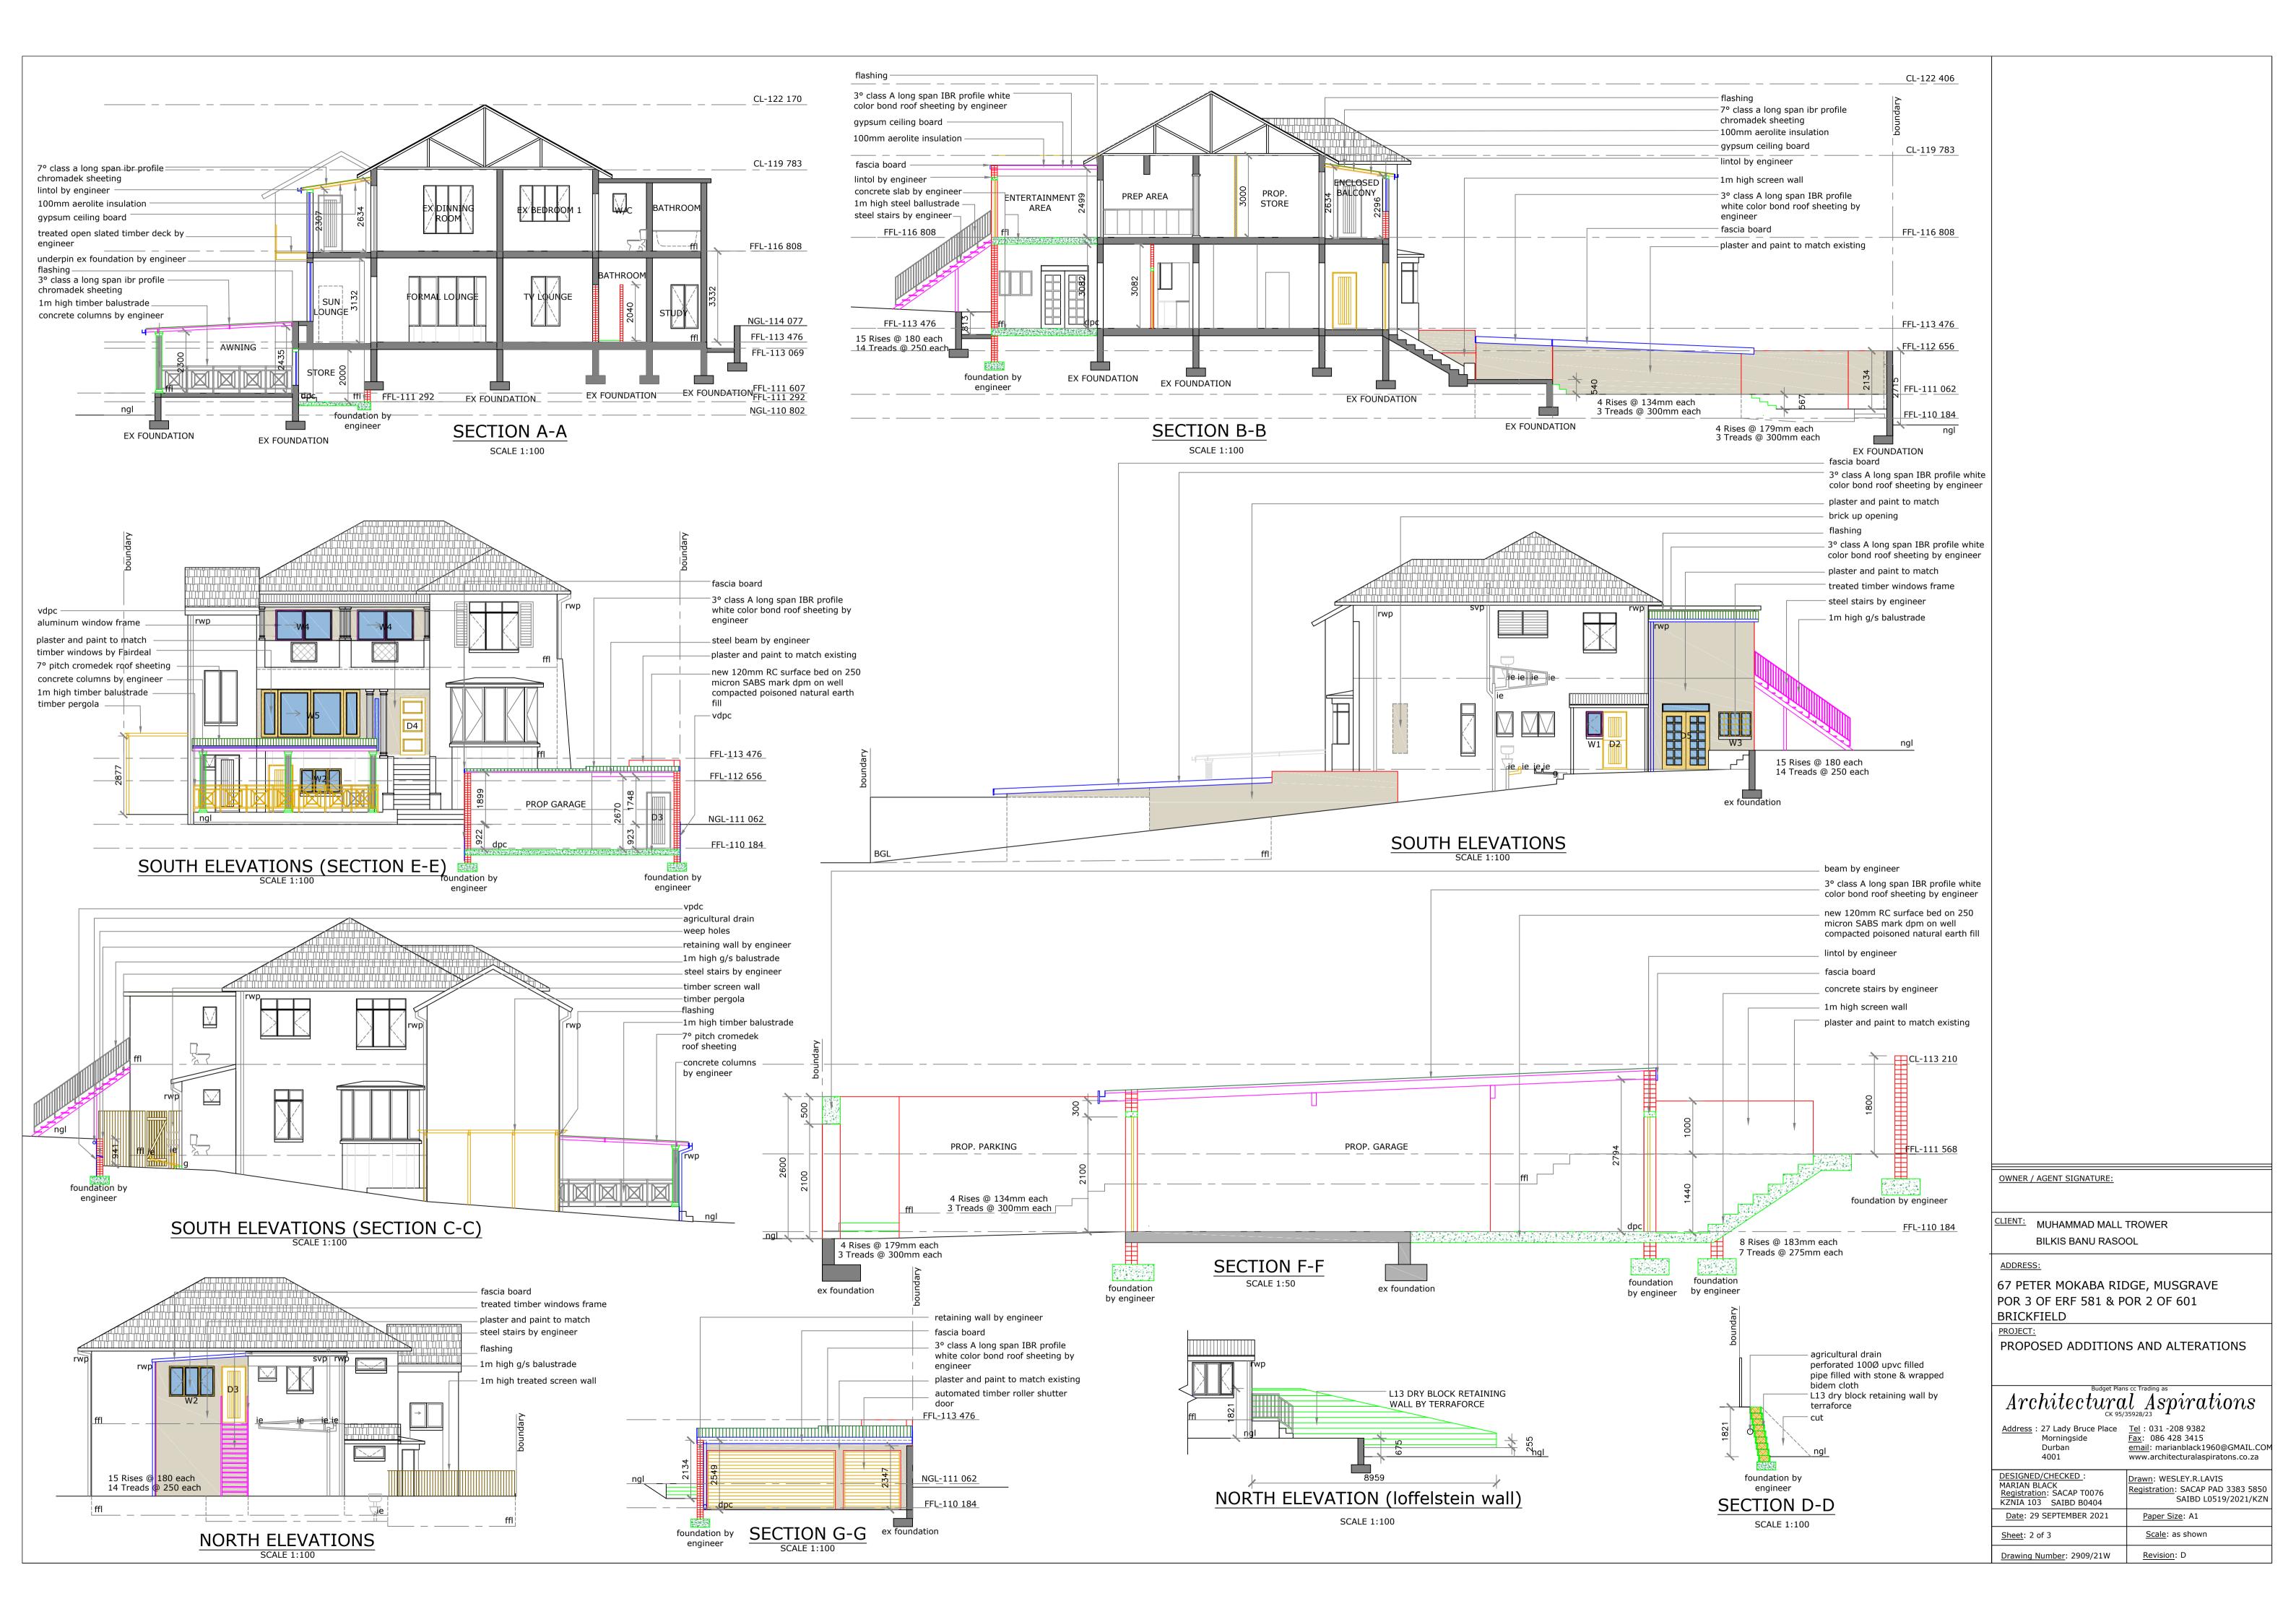

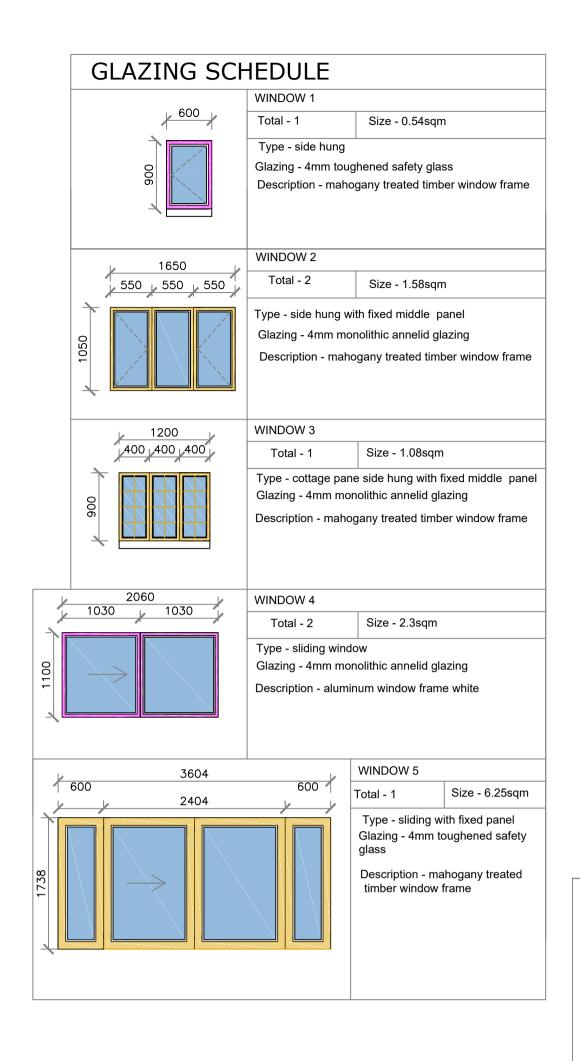

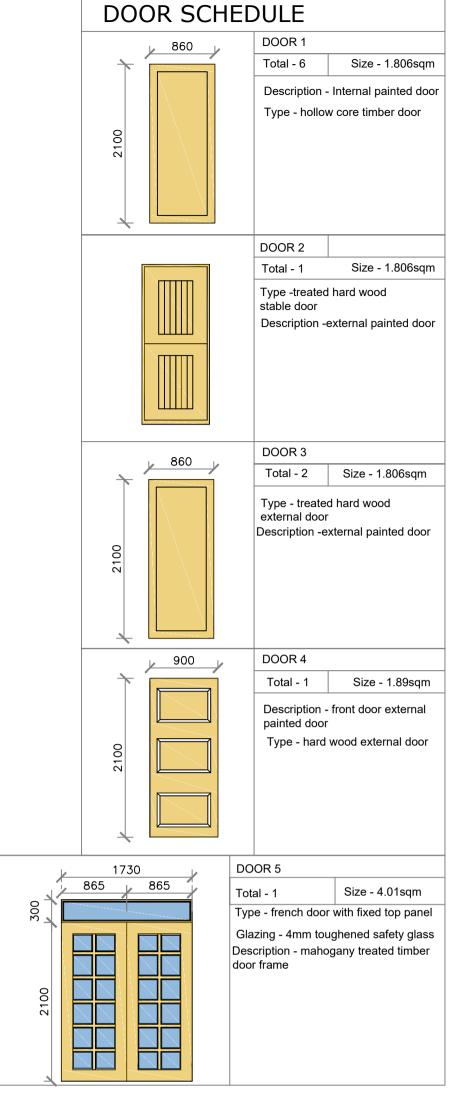

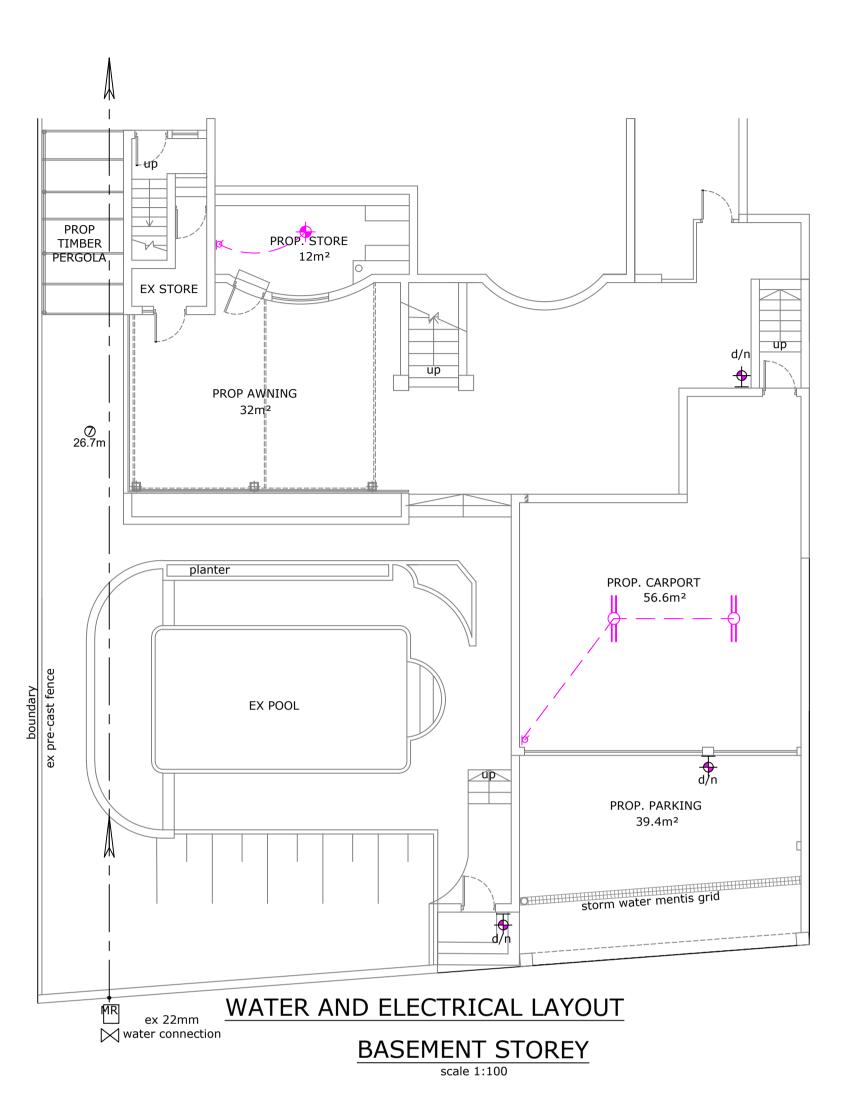

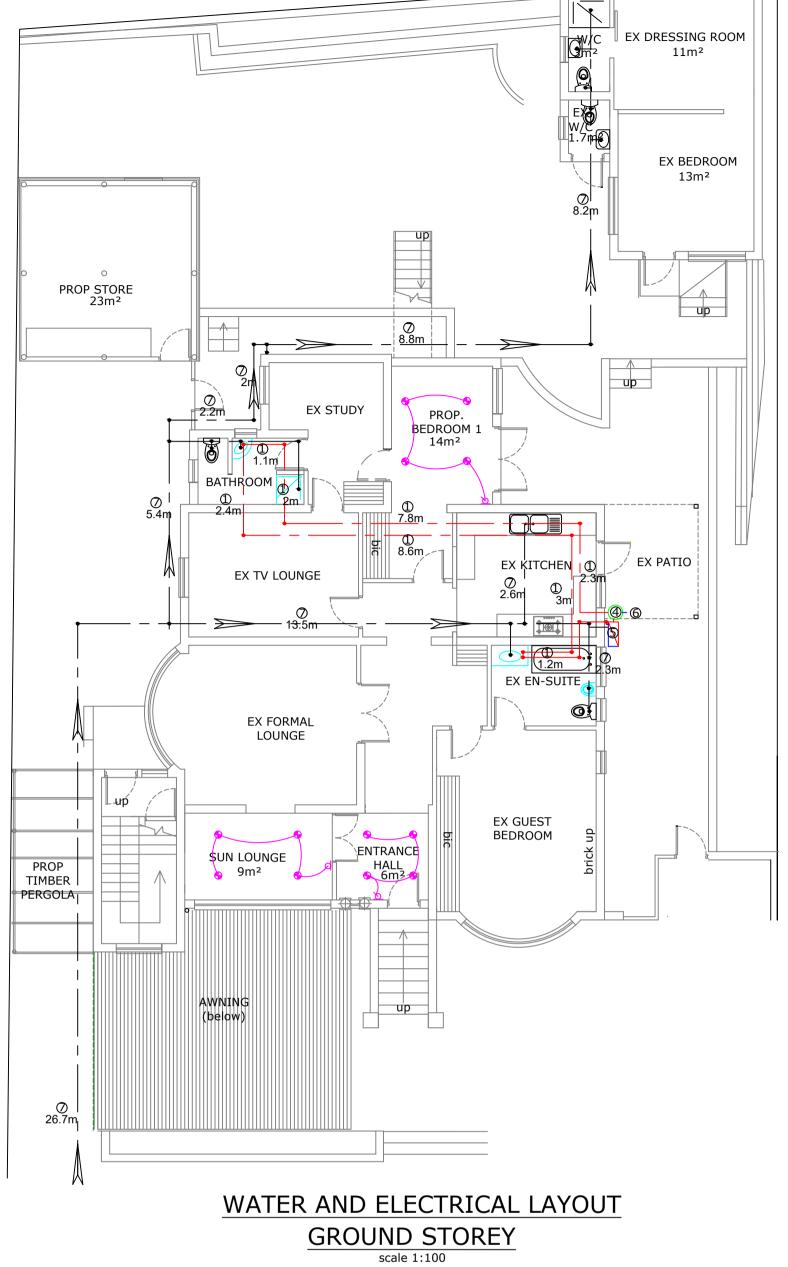

FENESTRATION AFFECTED BASEMENT STOREY OTAL AREA (15%) Nett area basement Storey - 12 sqm x 15% = 1.8 sqm TOTAL NEW GLAZING basement Storey = 1.58sqm TOTAL FENESTRATION CALCULATIONS BASEMENT STOREY Net Floor Area: 12m<sup>2</sup> Fenestration: 1.58 sqm Ratio Percentage: 13.1% COMPLIES WITH SANS 204 AND SANS 10400 XA

PERMISSIBLE SHGC

NOTES:

HANDING &QUANTITY TO BE DETERMINED FROM LAYOUT DRAWINGS. ALL OPENINGS TO BE MEASURED PRIOR MANUFACTURING. DISCREPANCIES TO BE REPORTED TO

DEVIATION FROM DRAWINGS AND/OR SPECIFICATION TO BE DISCUSSED WITH AND APPROVED BY THE ARCHITECT/CLIENT PRIOR TO MANUFACTURE.

DRAWING NOT TO BE MEASURED, ONLY READ

ENERGY EFFICIENCY OF GLAZING ELEMENTS GROUND STOREY CLIMATE ZONE 5 OCCUPANCY H3 NETT FLOOR AREA GROUND STOREY =  $59.5m^2 \times (15\% = 5.76m^2 \text{ permissible})$ PERMISSIBLE CONDUCTANCE - (1.4) X 59.5sqm = 83.3

 $-(0.11) \times 59.5 \text{sqm} = 6.545$ 

WINDOW TYPE HEIGHT WIDTH AREA U-VALUE U-COAST G G P H (A) (U) (AXU) G-effect ORIENTATION E-FACTOR SHGC SHGC COST A x E x SHGC EAST 1.13 0.68 4.8025 1.738m 3.6m 6.25m 3 18.75 0.1m 1 0.1m 1.838m 0.054 NORTH 0.27 0.68 0.099144 0.9m 0.6m 0.54m 4.23 2.2842 0.1m 1 0.3m 0.7m 0.43 
 2.4m
 1.71m
 4.01m
 3
 12.03
 3m
 0.5
 0.2m
 5.4m
 0.019
 NORTH
 0.44
 0.72
 1.270368

 0.9m
 1.2m
 1.08m
 5.6
 6.048
 3.2m
 0.5
 0.2m
 4.1m
 0.024
 NORTH
 0.44
 0.77
 0.365904


 AGGREGATE CONDUCTANCE=
 39.1122
 NORTH 0.44 0.72 1.270368

CONDUCTANCE AND SHGC IS BELOW THAN PERMISSIBLE AND COMPLIES WITH SANS 10400 - 204 AND SANS 10400 XAGGREGATE SHGC=

ENERGY EFFICIENCY OF GLAZING ELEMENTS FIRST STOREY OCCUPANCY H3 NETT FLOOR AREA FIRST STOREY =  $32m^2 \times (15\% = 4.8m^2 \text{ permissible})$ PERMISSIBLE CONDUCTANCE - (1.4) X 32sqm = 44.8 PERMISSIBLE SHGC  $-(0.11) \times 32$ sqm = 3.52

WINDOW TYPE | HEIGHT | WIDTH | AREA | U-VALUE | U-COAST | G | G | effect | P | H | G-effect | ORIENTATION | E-FACTOR | SHGC | COST | A x E x SHGC | SHGC | COST | A x E x SHGC | SHGC | COST | A x E x SHGC | SHGC | COST 
 Window 2
 1.05m
 1.65m
 1.58m
 5.6
 8.848
 0.1m
 1
 0.3m
 1.15m
 0.26
 WEST
 0.96
 0.77
 1.167936
 AGGREGATE CONDUCTANCE= 18.577 AGGREGATE SHGC= 2.741136

CONDUCTANCE AND SHGC IS BELOW THAN PERMISSIBLE AND COMPLIES WITH SANS 10400 - 204 AND SANS 10400 XA

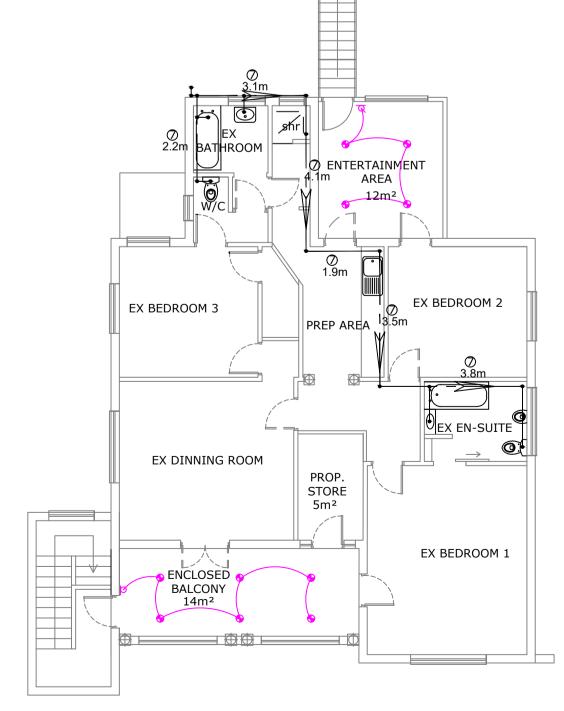

WATER AND ELECTRICAL LAYOUT FIRST STOREY

| 9  | <b>⋈</b>  | LIGHT SWIT        | CH SINGLE          |                        |                    |
|----|---|-------------------|--------------------|------------------------|--------------------|
| 4  | <u> </u>  | DOUBLE FLOR       | RESCENT TU         | BE LIGHT               | 12w                |
| 2  | <b>+</b>  | CEILING LIG       | HTS <sup>5</sup> w |                        |                    |
| 22 | <b>4</b>  | DOWN LIGH         | ITS 3w             |                        |                    |
| 3  | <del>                                      </del> | WALL LIGHT        | S 6w with c        | lay night ce           | ensor              |
| _  | OUBLE FI<br>EILING LI<br>OWN LIG                  | LORESCENT<br>GHTS | of lights 4        | watts<br>12<br>12<br>3 | hrs<br>8<br>8<br>8 |
| D  | OVVIV LIG   | 1112              | 22                 | 3                      | O                  |
| _  | /ALL LIGH   | –                 | 3                  | 6                      | 8                  |

|   | LEGEND |   |  |
|---|--------|---|--|
| 1 |        | -15mm hot water pipe  |  |
| 2 |        | -20mm cold water pipe   |  |
| 3 | X      | - ex isolating valve  |  |
| 4 | 0      | - 200L hp storage water heater                                  |  |
| 5 | Ď      | -heat pump  |  |
| 6 |        | -50mm overflow pipe direct from drip trayto discharge externaly |  |
| 7 |        | -EX 20mm cold water pipe  |  |

| ADDRESS:                           |
|------------------------------------|
| 67 PETER MOKABA RIDGE, MUSGRAVE    |
| POR 3 OF ERF 581 & POR 2 OF 601    |
| BRICKFIELD                         |
| PROJECT:                           |
| PROPOSED ADDITIONS AND ALTERATIONS |
|                                    |

OWNER / AGENT SIGNATURE:

<u>Sheet</u>: 3 of 3

Drawing Number: 2909/21W

CLIENT: MOHAMMAD MALL TROWER

BILKUS BANU RASOOL

| Architectural A spirations  |  |  |  |  |  |
|---|--|--|--|--|--|
| Tel: 031 -208 9382 Fax: 086 428 3415 email: marianblack1960@GMAIL.COM www.architecturalaspiratons.co.za |  |  |  |  |  |
| <u>Drawn</u> : WESLEY.R.LAVIS<br><u>Registration</u> : SACAP PAD 3383 5850<br>SAIBD L0519/2021/KZN      |  |  |  |  |  |
| Paper Size: A1  |  |  |  |  |  |
|   |  |  |  |  |  |

Scale: as shown