

New Brick wall plaster

coping as per Part K

No part of foundations

New RC foundations to

Engineers details and

design

SECTION B-B

SCALE 1:50

and painted on both sides with 75mm


plastered corbelled

of SANS 10400

to encroach over

boundary

SOUTH EAST ELEVATION of boundary wall scale 1:100

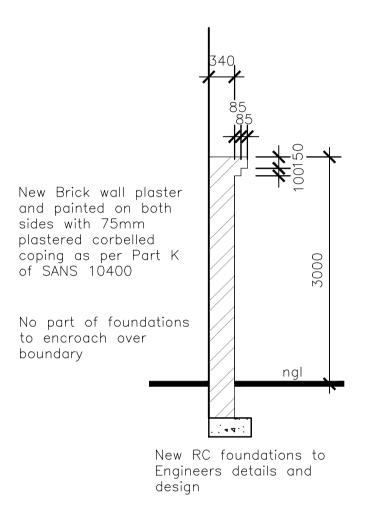


T.O.W = 122 300

FGL BEYOND

FGL = 119 300

SECTION C-C SCALE 1:50

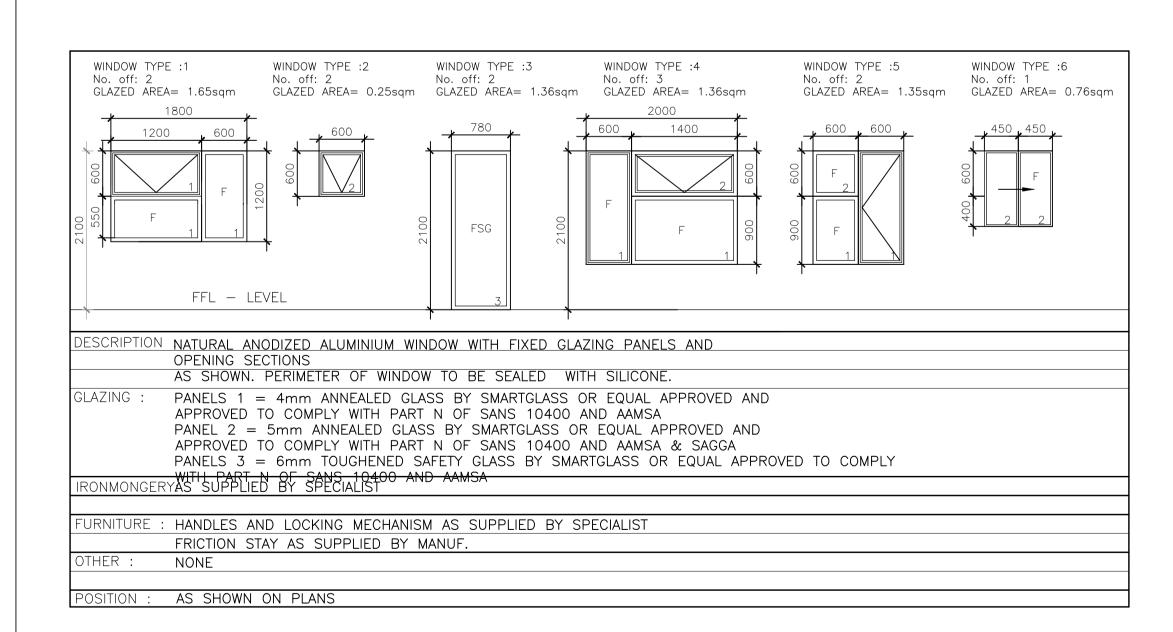

NOTES

1-New Chromodek roof sheeting at 2 degree monopitch on GMS purlins on GMS 150 square hollow sections fixed into 150x 150mm Concrete foundations to engineers details.

2-New aluminium louvered panels in between with rodent proof mesh backing

3-New treated Timber panels fixed tto 150x150mm GMS sections with angle cleates to engineers details

falls into new gulley on approved underlay well compacted and poisoned soil and connect to exg. s/water line

5—New concrete foundations to Engineers details

hinges and bolt and lock to later detail

7-New retaining wall & waterproofing to Engineers details

8-New s/water catch to connect to existing s/water line

9-New selected paving to new driveway

ramp down. Ramp gradient at 1:8 fall

permeable paving finish to engineers details

11— New Disabled parking bays

14-New screen wall made up of 50mm wide treated panels fixed to 150mm GMS square hollow sections at 1500mm high around New Service Yard with gate in positions as shown. Post foundations to

15-New 110mmuPVC soil pipe to connect to Existing Manhole—refer sewer section

fluted bases as shown

17-New double pivot glazed powder coated door and side panels as per Glazing schedule

19-New powder coated window frames and glazing as per glazing schedule

4-New concrete floor with screeds to

6—New treated Timber gate with GMS

10-New 2500x4900 Parking Bays with

12- New 6000x4000mm Loading Bay

13-New Landscaped Garden by Landscape Architect to later details

engineers details

16-New 220x600mm RC columns wih RC beam over to Engineers details with

18-Exisitng Ancillary unit to be demolished. Existing sewer and stormwater lines to be abandoned 20-Part Existing sewer line to be encased in concrete as per Engineers details. sewer pipe to be replaced if found to be in a poor condition

21— New internal brickwork to be smooth plaster and paint finish to match

22-New external brickwork to be plastered and painted to match existing.

23—Existing window to be removed, opening widened to create new link to proposed addition and made good to match existing

24-Existing Porch stairs and roof over with post support to be demolished

25-Existing window to be removed, opening bricked up and made good to match existing

26-Part existing wall to be demolished with new lintel over and new door to match existing with p&p to match existing

27-Exisiting Porch & steps with roof over to be demolished

28-Exg worktop & sink to be removed. door & frame to be removed to create new passage link

29-New 700x250 concrete foundations in compliance with SANS 1400

30-New 100mm surface bed on approved underlay on well compacted and poisoned soil in compliance with SANS 10400

31-New suspended floor slab with selected & approved waterproofing on screeds to falls to new fullbore outlets All to engineers details in compliance with SANS 10400.

32-New corbelled brickwork with plaster and paint finish

33-New p&p finish to New external brickwork to match existing in compliance with Part K of SANS 10400

34-New selected waterproofed Parapet

35-Existing wall and gate to be demolished as indicated with dashed line

36-Existing sewer pipe to be encased in

compliance with Part N of SANS 10400

concrete 37-New glazing as per schedule in

38-New plaster & paint finish to match

39—New solid timber meranti door and frame by owner

40-New white powder coated aluminium rainwater goods by specialist

GENERAL NOTES:

1. boundary beacons to be exposed and demarcated. 2. soil poisoning in accordance with SANS 10124 required. 3. do not scale drawings, use figured dimensions only.

4. all dimensions are, unless otherwise specified, measured in millimeters.

5. all dimensions, angles and levels to checked on site and any discrepancies are to be verified with the architect prior to the commencement of work.

6. all slabs, beams, columns, stairs and structural reinforced concrete and structural steel work

according to engineers details. 7. these drawings are to be read in conjunction with

structural, civil and mechanical engineers drawings. 8. all building work is to comply with SANS 1 0400 and local municipal by—laws.

9. all glazing thickness to comply with part N4.2.5 9.1. all safety glazing in accordance with N4.4

10. all facilities for disabled persons to comply with part s of sans 10400.

NOTE: certificate of stability to be issued on completion.

SIGNATURE

OWNER/CLIENT: SURANDAR SINGH X

GENERAL NOTE The Contractor is to verify all dimensions & levels on site before commencing work or producing shop drawings. Any discrepancies are to be reported to the Architect immediately. COPYRIGHT NOTE This drawing is subject to copyright and may not be eproduced, in whole or part, or in any manner whatsoevel without written permission from the architect.

CONTACT DETAILS:

084 625 4903

IDENTITY NUMBER:

<u>451227 5128 080</u>

Designs(Pty)Ltd P O Box 60886, Phoenix, 4080 Cell: +27 78 894 3897

RESPONSIBLE PERSON

CRAIG MOODLEY (Pr..Arch.T-PAT 20664)

Email: craigmoodley@gmail.com

SIGNATURE

Project Description PROPOSED ADDITIONS & ALTERATIONS TO EXISTING MEDICAL CONSULTING ROOMS

ON: PORTION 2 OF ERF 2753 DURBAN NORTH

FOR: SURANDAR SINGH FAMILY TRUST No. IT1645/1994

AT:195 KENNETH KAUNDA ROAD

(NORTHWAY), DURBAN NORTH

Date: 18/02/2013 Scale: A0 AS_SHOWN Drawn: CRAIG

Drawing Description

GLAZING SCHEDULE, SECTIONS & COVERED REFUSE AREA ELEVATIONS

AMAFA APPLICATION - SHEET 2 0F 2