


CONSTRUCTION NOTES: A. FOUNDATIONS : 1. To SABS 0400-1990 PART H. 20mpa Concrete foundations. 2. 220mm walls 250mm x 700mm. 3. 110mm walls 200mm x 600mm. 4. All foundations to be founded on solid ground. 5. Foundations in clay or shale subject to engineers approval. B. WALLS : 1. 220mm Cement bricks external walls. 2. 110mm Cement bricks internal walls. 3. Plaster & paint finish. 4. Brickforce every 4th course. 5. Two rows of wall tiles above sink & whb. Shower to be tiled to 1.8m. C. FLOORS : 1. 100mm thick concrete on well rammed earth fill, reinforced with weldmesh. Soil to be ant poisoned. Ceramic tile finish, 250 micron plastic sheet under floor 2. First floor slab to engineers detail and specifications. 1. Concrete roof tiles on 38 x 38 battens on trusses by roof specialist at 700cntrs. Plastic sheet under tiles. Wall plate 38 x 114, roof anchorage to be galvanised iron straps. 2. Exposed roof timber to be painted with carbolinium. Eave tiles to have storm clips. E. LINTOLS : 1. Pre-stressed precast concrete lintols. F. WINDOWS & GLAZING : 1. Windows to be steel windows. 2. All glazing is to be in accordance with NBR PART N. 3. Glazing to bathrooms and wc's to be in obscure glass. G. DOORS & FRAMES : 1. External doors to be aluminium cottage pane doors. 2. Internal doors to be catifoil. H. FASCIA & BARGE : 1. NUTEC fibre cement. I. GUTTER & DOWN PIPES : 1. 125ø P.V.C half round gutters. 2. 76¢ P.V.C down pipes. 1. Quarry cill tiles. K. VENTILATION : 1. Min two vermin-proofed air-bricks per room and on gable end walls. 1. Plastic or 3 ply malthoid under wall and under window cills. M. DRAINAGE : 1. All bends and junctions in drains to be provided with inspection eyes. 2. All sewer pipes to be $100 \text{mm} \phi$ p.v.c, All waste pipes to be 50mmø p.v.c. 3. Drainage work to comply with local authority by-laws. 5. Adequate access panels to be fitted in all ducts over inspection eyes. 6. Any pipes under floor to be encased in concrete. N. GENERAL NOTES : 1. Contractor to view site before tendering, All dimensions & levels to be checked on site prior to commencement of any EAG ARCHITECTS work. All queries to be directed to the author. 2. Contractor to visit site before tender. 3. All work to be in accordance with N.B.R and to the satisfaction of the local authority. **O. SITING & EXCAVATIONS :** Contact : 079 427 4337/ 083 785 5871 1. All boundary beacons are to be flagged by a registered land Fax : 031 208 5459 surveyor and the contractor is to obtain a certificate stating Email : eagarchitects@live.co.za that the work has been correctly set out before proceeding with excavations. 2. Contractor is to check all dimensions and levels before commencing work and report any discrepancies to drawing service. ARCHITECTURAL, CONCEPTUAL AND INTERIOR DESIGN 3. Contractor is to confirm and ensure correctness of floor and entrance levels physically on site with local authority inspector before commencing work. ZONE SPECIAL RESIDENTIAL 4. If the site is found to contain clay, shale, ground water or any other suspect soil condition, then all foundations are to be to professional engineer's details and built under his supervision. CLIENT : 5. All foundations to be taken to hard, virgin ground. No back filling Mr A.R. ABBU over excavated areas will be permitted. Foundation depths to be determined on site. 6. Maximum gradient of unretained banks to be cut not to exceed CLIENT SIGNATURE : 26° NGL and FGL in approximate position, no claim can be made for discrepancy on site. JOB TITLE : P. LOCAL AUTHORITY : PROPOSED ALTERATIONS & FIRST FLOOR ADDITION 1. The contractor is responsible for all local authority notices TO EXISTING DWELLING ON 49 ERF 39 OF THE FARM DURBAN NORTH, NO 51 KENNETH KAUNDA 2. The contractor is required to obtain all necessary connections ROAD ATHLONE to services. 3. Where local authority or government regulations require more stringent specification than shown herein, they are to be followed with prior consent of the owner. 4. The contractor is to inspect the official approved copies of the DESIGNED BY: B.E.Saul drawing to ensure that all amendments have been taken into account. REGISTRATION No: T0436 5. All NBR and SABS standards and specifications are to be adhered to as a minimum standard and good construction principles. P.0. BOX 352 6. All levels are approximate. MANDENI, 4490 Cell: 083 785 5871 Q. ENGINEERS : 1. Engineer to check foundations and walls on existing building DRAWN BY : for structural integrity for first floor addition. GARETH NORRIS DRAWING DESCRIPTION SECTION & ELEVATIONS DATE : SCALE : 06:08:2014 1:100, 1:200 DRAWING No : 00/2014SD

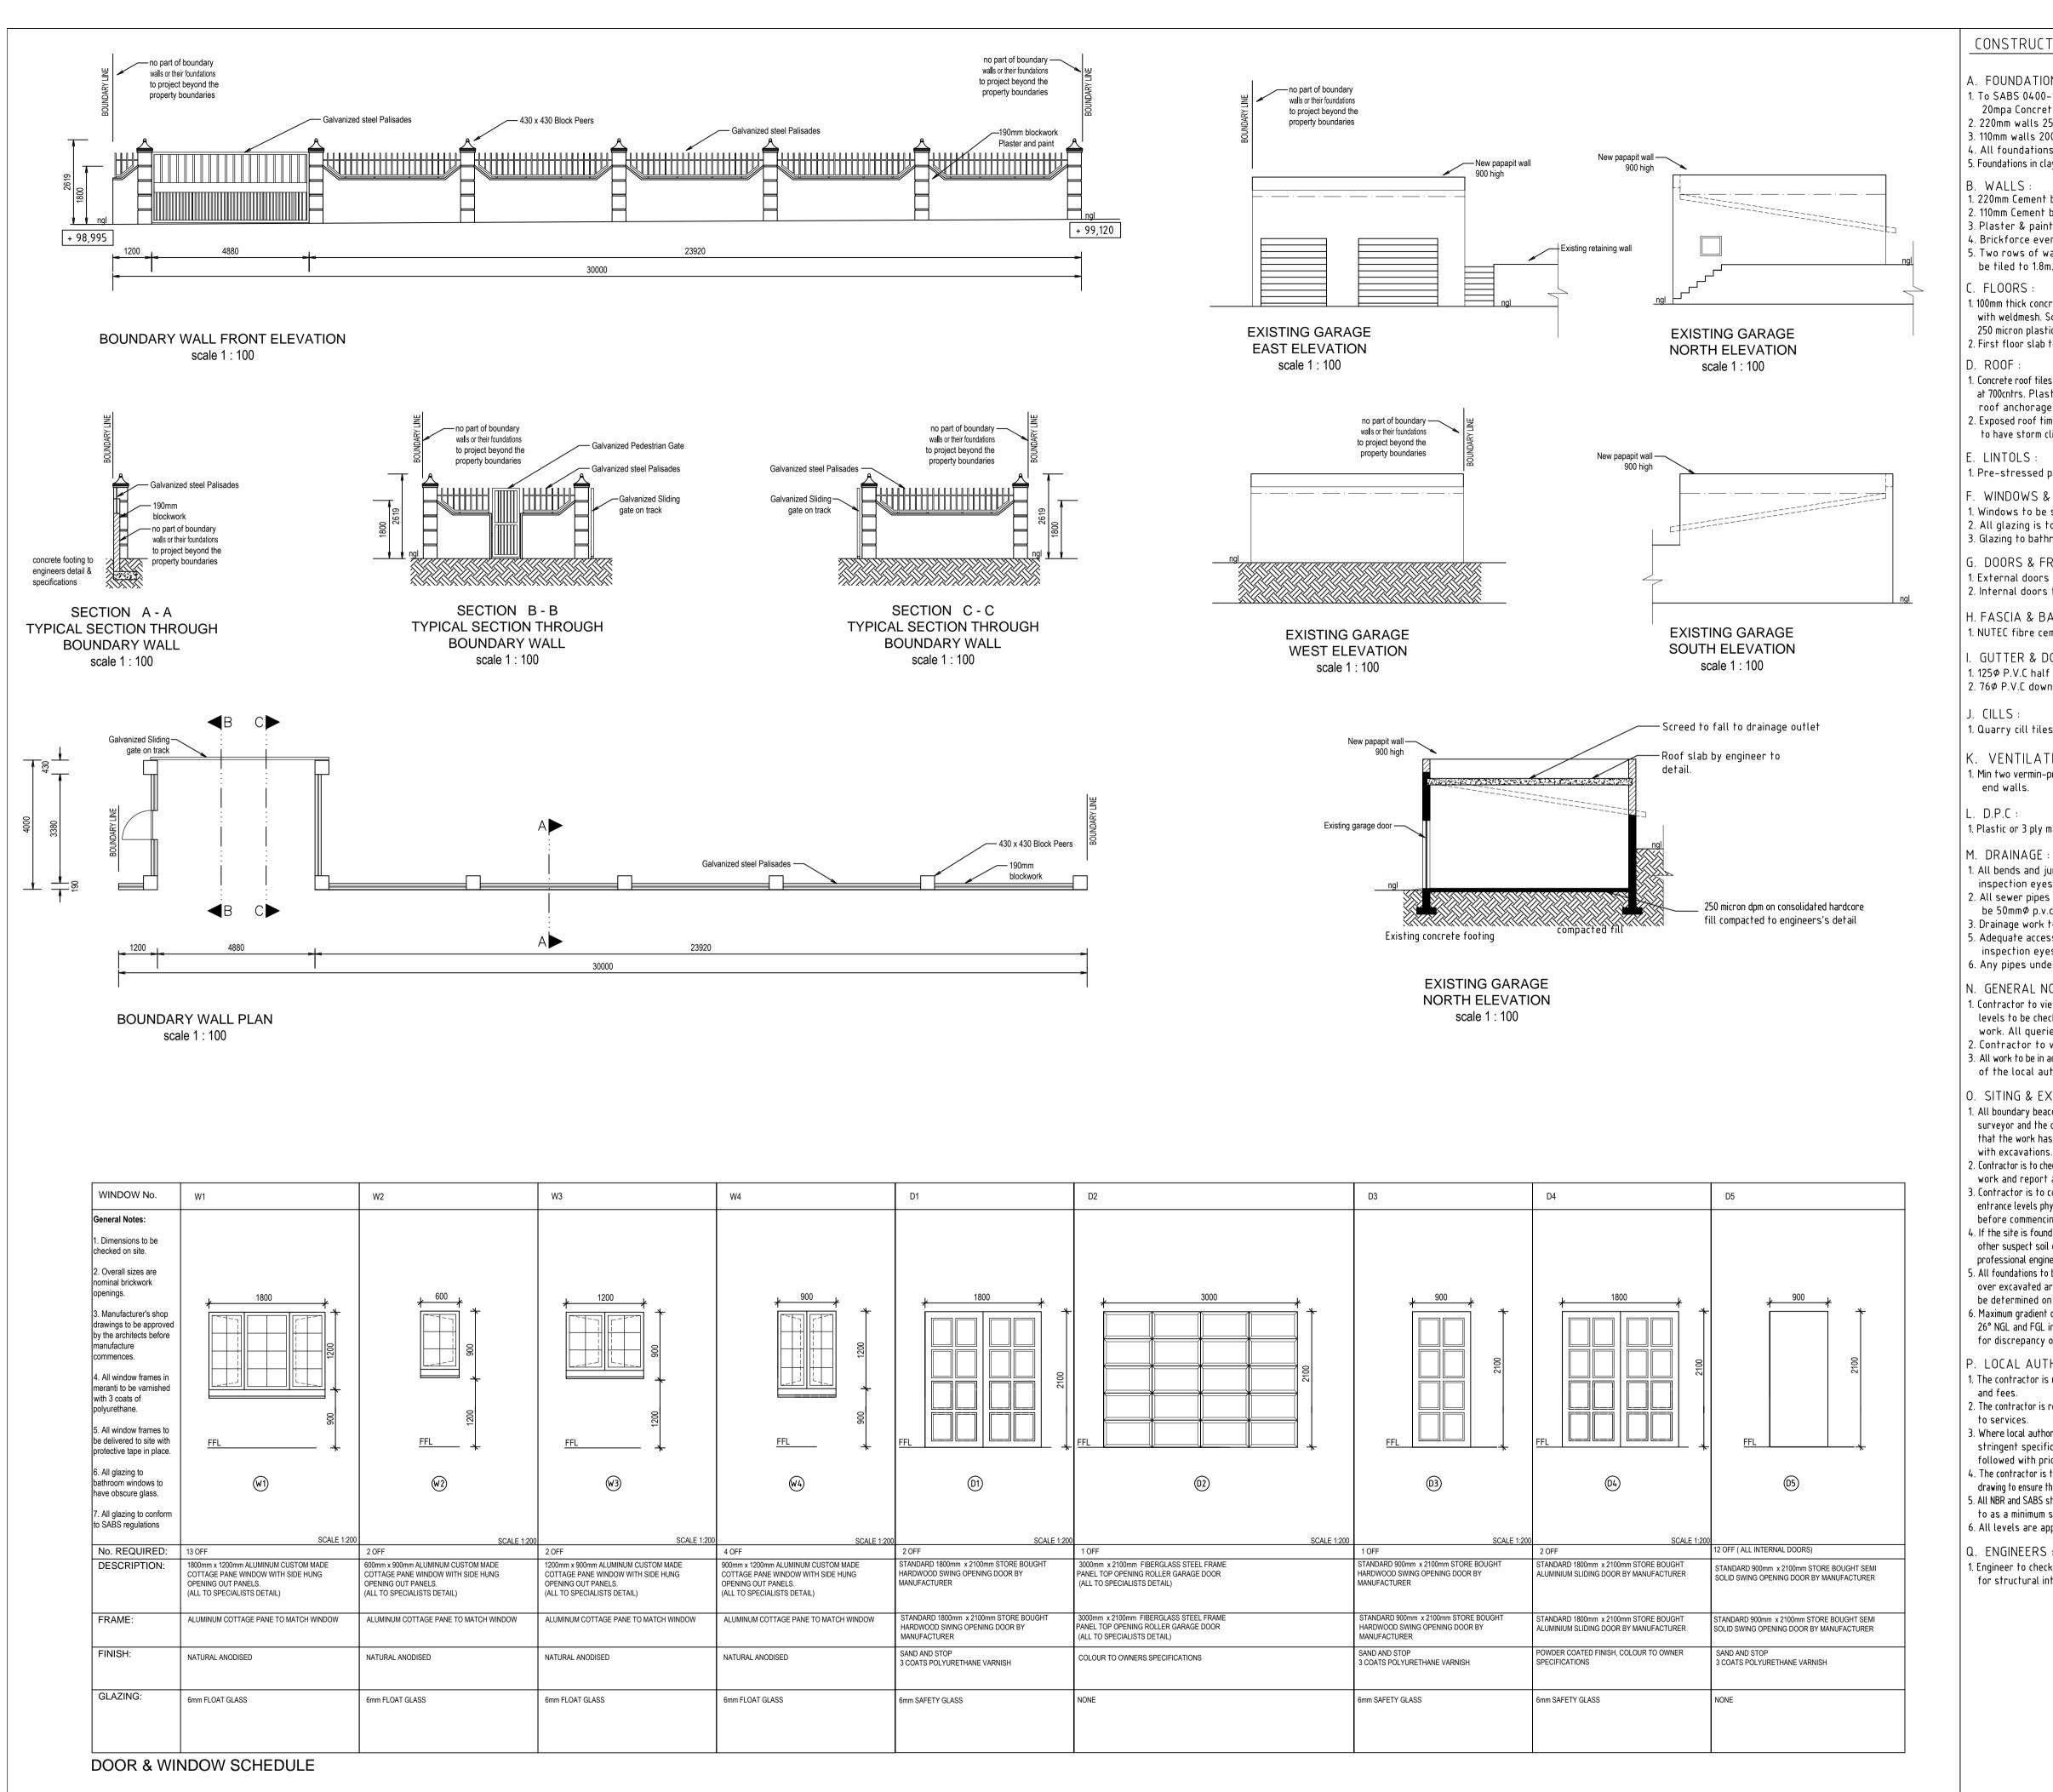

CONSTRUCTION NOTES: A. FOUNDATIONS : 1. To SABS 0400-1990 PART H. 20mpa Concrete foundations. 2. 230mm walls 250mm x 700mm. 3. 115mm walls 200mm x 600mm. 4. All foundations to be founded on solid ground. 5. Foundations in clay or shale subject to engineers approval. B. WALLS : 1. 220mm Cement bricks external walls. 2. 110mm Cement bricks internal walls. 3. Plaster & paint finish. 4. Brickforce every 4th course. 5. Two rows of wall tiles above sink & whb. Shower to be tiled to 1.8m. C. FLOORS : 1. 100mm thick concrete on well rammed earth fill, reinforced with weldmesh. Soil to be ant poisoned. Ceramic tile finish, 250 micron plastic sheet under floor 2. First floor slab to engineers detail and specifications. D. ROOF : 1. Concrete roof tiles on 38 x 38 battens on trusses by roof specialist at 700cntrs. Plastic sheet under tiles. Wall plate 38 x 114, roof anchorage to be galvanised iron straps. 2. Exposed roof timber to be painted with carbolinium. Eave tiles to have storm clips. E. LINTOLS : 1. Pre-stressed precast concrete lintols. F. WINDOWS & GLAZING : 1. Windows to be aluminium cottage pane windows. 2. All glazing is to be in accordance with NBR PART N. 3. Glazing to bathrooms and wc's to be in obscure glass. G. DOORS & FRAMES : 1. External doors to be meranti hardwood. 2. Internal doors to be catifoil. H. FASCIA & BARGE : 1. NUTEC fibre cement. . GUTTER & DOWN PIPES : 1. 125ø P.V.C half round gutters. 2. 76¢ P.V.C down pipes. J. CILLS : 1. Quarry cill tiles. K. VENTILATION : EAG ARCHITECTS 1. Min two vermin-proofed air-bricks per room and on gable end walls. .. D.P.C : 1. Plastic or 3 ply malthoid under wall and under window cills. Contact : 079 427 4337/ 083 785 5871 M. DRAINAGE : Fax : 031 208 5459 1. All bends and junctions in drains to be provided with Email : eagarchitects@live.co.za inspection eyes. 2. All sewer pipes to be 100mmØ p.v.c, All waste pipes to be 50mmø p.v.c. 3. Drainage work to comply with local authority by-laws. ARCHITECTURAL, CONCEPTUAL AND INTERIOR DESIGN 5. Adequate access panels to be fitted in all ducts over inspection eyes. 6. Any pipes under floor to be encased in concrete. ZONE SPECIAL RESIDENTIAL N. GENERAL NOTES : 1. Contractor to view site before tendering, All dimensions & SCHEDULE OF AREAS :levels to be checked on site prior to commencement of any work. All queries to be directed to the author. PORTION ERF OF THE FARM 49 ERF 39 1260.00 sqm 2. Contractor to visit site before tender. 3. All work to be in accordance with N.B.R and to the satisfaction EXIST DWELLING 235.20 sqm of the local authority. EXISTING GARAGE 42.85 sqm EXISTING OUTBUILDING 15.71 sqm 0. SITING & EXCAVATIONS : 293.76 sqm TOTAL EXISTING BUILDING AREA 1. All boundary beacons are to be flagged by a registered land surveyor and the contractor is to obtain a certificate stating PROPOSED FIRST FLOOR EXCL BALCONIES 225.60 sqm that the work has been correctly set out before proceeding PROPOSED BALCONIES 56.93 sqm 282.53 sqm with excavations. PROPOSED NEW BUILDING AREA 2. Contractor is to check all dimensions and levels before commencing work and report any discrepancies to drawing service. 576.29 sqm PROPOSED TOTAL BUILDING AREA 3. Contractor is to confirm and ensure correctness of floor and entrance levels physically on site with local authority inspector COVER 24.64 % before commencing work. 35.62 % F.A.R. 4. If the site is found to contain clay, shale, ground water or any other suspect soil condition, then all foundations are to be to professional engineer's details and built under his supervision. CLIENT : 5. All foundations to be taken to hard, virgin ground. No back filling Mr A.R. ABBU over excavated areas will be permitted. Foundation depths to be determined on site. 6. Maximum gradient of unretained banks to be cut not to exceed CLIENT SIGNATURE : 26° NGL and FGL in approximate position, no claim can be made for discrepancy on site. JOB TITLE : P. LOCAL AUTHORITY : PROPOSED ALTERATIONS & FIRST FLOOR ADDITION 1. The contractor is responsible for all local authority notices TO EXISTING DWELLING ON 49 ERF 39 OF THE and fees. FARM DURBAN NORTH, NO 51 KENNETH KAUNDA 2. The contractor is required to obtain all necessary connections ROAD ATHLONE to services. 3. Where local authority or government regulations require more stringent specification than shown herein, they are to be followed with prior consent of the owner. 4. The contractor is to inspect the official approved copies of the DESIGNED BY: B.E.Saul drawing to ensure that all amendments have been taken into account. REGISTRATION No: T0436 5. All NBR and SABS standards and specifications are to be adhered to as a minimum standard and good construction principles. P.0. BOX 352 6. All levels are approximate. MANDENI, 4490 Cell : 083 785 5871 DRAWN BY : GARETH NORRIS DRAWING DESCRIPTION SITE PLAN, FLOOR PLANS DATE : SCALE : 1:100, 1:200 06:08:2014 DRAWING No :

00/2014SD



CONSTRUCTION NOTES : A. FOUNDATIONS 1. To SABS 0400-1990 PART H. 20mpa Concrete foundations. 2. 220mm walls 250mm x 700mm. 3. 110mm walls 200mm x 600mm. 4. All foundations to be founded on solid ground. 5. Foundations in clay or shale subject to engineers approval. 1. 220mm Cement bricks external walls. 2. 110mm Cement bricks internal walls. 3. Plaster & paint finish. 4. Brickforce every 4th course. 5. Two rows of wall tiles above sink & whb. Shower to be tiled to 1.8m. 1. 100mm thick concrete on well rammed earth fill, reinforced with weldmesh. Soil to be ant poisoned. Ceramic tile finish, 250 micron plastic sheet under floor 2. First floor slab to engineers detail and specifications. 1. Concrete roof tiles on 38 x 38 battens on trusses by roof specialist at 700cntrs. Plastic sheet under tiles. Wall plate 38 x 114, roof anchorage to be galvanised iron straps. 2. Exposed roof timber to be painted with carbolinium. Eave tiles to have storm clips. 1. Pre-stressed precast concrete lintols. -. WINDOWS & GLAZING : 1. Windows to be steel windows. 2. All glazing is to be in accordance with NBR PART N. 3. Glazing to bathrooms and wc's to be in obscure glass. G. DOORS & FRAMES : 1. External doors to be aluminium cottage pane doors. 2. Internal doors to be catifoil. H. FASCIA & BARGE 1. NUTEC fibre cement. . GUTTER & DOWN PIPES : 1. 125ø P.V.C half round gutters. 2. 76¢ P.V.C down pipes. 1. Quarry cill tiles. K. VENTILATION 1. Min two vermin-proofed air-bricks per room and on gable 1. Plastic or 3 ply malthoid under wall and under window cills. 1. All bends and junctions in drains to be provided with inspection eyes. 2. All sewer pipes to be $100 \text{mm} \phi$ p.v.c, All waste pipes to be 50mmø p.v.c. 3. Drainage work to comply with local authority by-laws. 5. Adequate access panels to be fitted in all ducts over inspection eyes. 6. Any pipes under floor to be encased in concrete. N. GENERAL NOTES : 1. Contractor to view site before tendering, All dimensions & levels to be checked on site prior to commencement of any EAG ARCHITECTS work. All queries to be directed to the author. 2. Contractor to visit site before tender. 3. All work to be in accordance with N.B.R and to the satisfaction of the local authority. 0. SITING & EXCAVATIONS Contact : 079 427 4337/ 083 785 5871 1. All boundary beacons are to be flagged by a registered land Fax : 031 208 5459 surveyor and the contractor is to obtain a certificate stating Email : eagarchitects@live.co.za that the work has been correctly set out before proceeding with excavations. 2. Contractor is to check all dimensions and levels before commencing work and report any discrepancies to drawing service. ARCHITECTURAL, CONCEPTUAL AND INTERIOR DESIGN 3. Contractor is to confirm and ensure correctness of floor and entrance levels physically on site with local authority inspector ZONE SPECIAL RESIDENTIAL before commencing work. 4. If the site is found to contain clay, shale, ground water or any other suspect soil condition, then all foundations are to be to professional engineer's details and built under his supervision. CLIENT : 5. All foundations to be taken to hard, virgin ground. No back filling Mr A.R. ABBU over excavated areas will be permitted. Foundation depths to be determined on site. 6. Maximum gradient of unretained banks to be cut not to exceed CLIENT SIGNATURE : 26° NGL and FGL in approximate position, no claim can be made for discrepancy on site. JOB TITLE : P. LOCAL AUTHORITY **PROPOSED ALTERATIONS & FIRST FLOOR ADDITION** 1. The contractor is responsible for all local authority notices TO EXISTING DWELLING ON 49 ERF 39 OF THE FARM DURBAN NORTH, NO 51 KENNETH KAUNDA 2. The contractor is required to obtain all necessary connections ROAD ATHLONE 3. Where local authority or government regulations require more stringent specification than shown herein, they are to be followed with prior consent of the owner. 4. The contractor is to inspect the official approved copies of the DESIGNED BY: B.E.Saul drawing to ensure that all amendments have been taken into account. REGISTRATION No: T0436 5. All NBR and SABS standards and specifications are to be adhered to as a minimum standard and good construction principles. P.0. BOX 352 6. All levels are approximate. MANDENI, 4490 Cell: 083 785 5871 1. Engineer to check foundations and walls on existing building DRAWN BY : for structural integrity for first floor addition. GARETH NORRIS DRAWING DESCRIPTION SECTION & ELEVATIONS DATE : SCALE : 1:100, 1:200 06:08:2014 DRAWING No : 00/2014SD