

GENERAL NOTES

1. ALL WORK TO COMPLY WITH CLIENT STANDARDS AND RELEVANT S.A.B.S. (SANS) CODES OF PRACTICE
2. READ FIGURED DIMENSIONS IN PREFERENCE TO SCALING
3. ALL DIMENSIONS AND LEVELS TO BE VERIFIED ON SITE BY CONTRACTOR PRIOR TO COMMENCEMENT OF WORK
4. SETTING OUT TO BE CONFIRMED AND APPROVED BY PROJECT ENGINEER PRIOR TO CONSTRUCTION
5. ONLY WORK FROM CONSTRUCTION ISSUE DRAWINGS MUST BE UNDERTAKEN
6. ALL REINFORCED CONCRETE WORK TO ENGINEERS SPECIFICATIONS

THIS DRAWING IS ISSUED FOR:-

- | | | | |
|------------------|-------------------------------------|--------------|--------------------------|
| CLIENTS APPROVAL | <input type="checkbox"/> | FABRICATION | <input type="checkbox"/> |
| INFORMATION | <input type="checkbox"/> | CONSTRUCTION | <input type="checkbox"/> |
| COMMENTS | <input type="checkbox"/> | REFERENCE | <input type="checkbox"/> |
| TENDER | <input type="checkbox"/> | AS BUILT | <input type="checkbox"/> |
| EIA APPLICATION | <input checked="" type="checkbox"/> | | |

SIGNED:..... DATE:.....

ISSUED FOR APPROVAL

No.	DATE	AMENDMENT	APPR'D
0.12	12/08/19	RE ISSUED WITH ENVIRONMENTAL APPLICATION	
0.11	14/06/19	ISSUED WITH ENVIRONMENTAL APPLICATION	
0.10	21/05/19	ISSUED FOR MUNICIPAL APPROVAL	
0.9	21/01/19	AMENDED PER DISCUSSION	
0.8	09/08/18	ISSUED FOR FIRE DEPT APPROVAL	

cad file name
090817-G-001.dwg

client/ customer



RUSTENBURG DEPOT

consultant/departmental



discipline
GENERAL

customer

Q4 (PTY) LTD

project number

J090817

drawing title

PROPOSED SITE DEVELOPMENT LAYOUT
ERF 2265
RUSTENBURG EXTENSION 9
COBALT STREET - INDUSTRIAL


ref.no G001 designed N. CHAMBERLIN

scale AS SHOWN ON A1 drawn PSDS

date 20/08/2017 checked

type number

drawing number revision
090817-G-001B REV 0.12

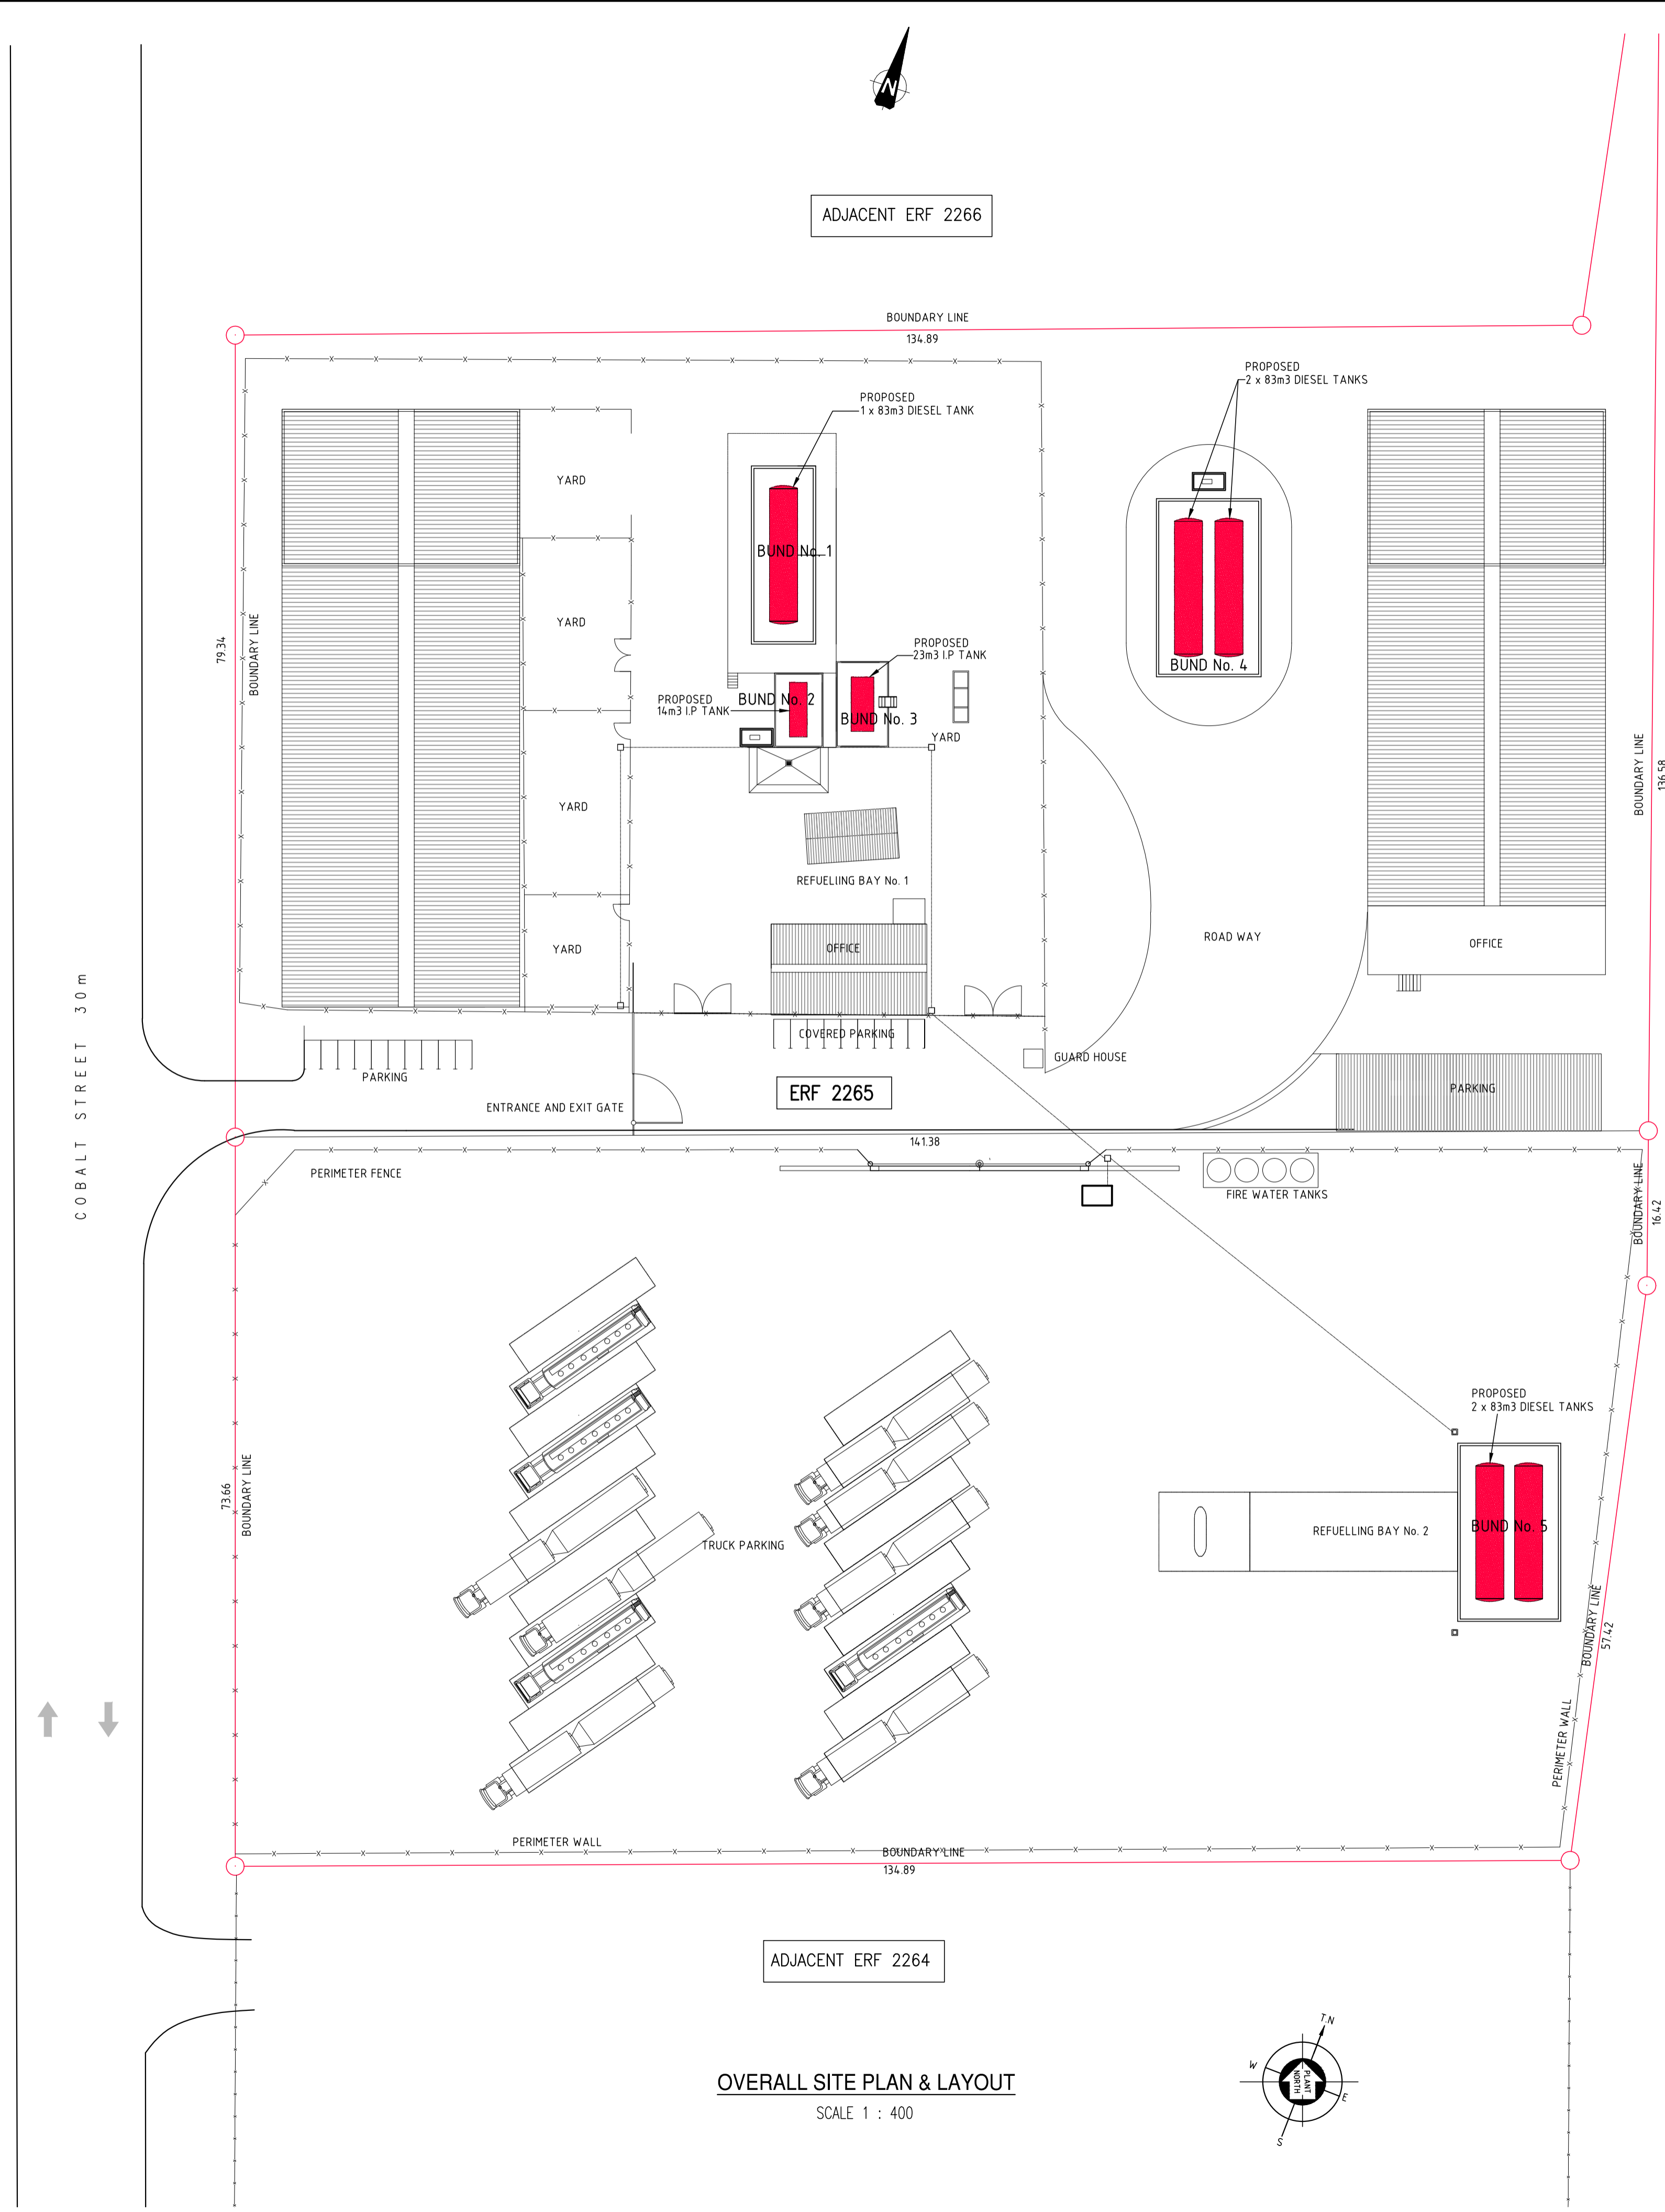

OVERALL SITE PLAN & LAYOUT
SCALE 1 : 400

SCHEDULE OF AREAS		
ITEM	BUND	FOOTPRINT/ AREA
01	BUND No. 1	18m x 6.5m = 117m ²
02	BUND No. 2	8.6m x 4.9m = 42m ²
03	BUND No. 3	8.6m x 5.3m = 46m ²
04	BUND No. 4	18m x 10.5m = 189m ²
05	BUND No. 5	18m x 10.5m = 189m ²
		TOTAL AREA = 583m ²
06	REFUELLING BAY No. 1	9.3m x 5m = 47m ²
07	REFUELLING BAY No. 2	30m x 8m = 240m ²
		TOTAL AREA = 287m ²

TOTAL PROPOSED SITE CAPACITY = 5 x 83m³ + 1x 23 m³ + 1x 14m³
= 452m³

ISSUE FOR APPROVAL

CONTROLLED COPY