





construction notes:

- 01 **internal floorfinish:**
grano
- 02 **internal floorfinish:**
ceramic tile as per approved sample
- 03 **dpc:**
Gundl@ API A.T USB Green 250µm damp proof membrane under concrete surface beds conforming to SANS 952-1:2011 laid with minimum 150mm overlaps and sealed with Gunplas pressure sensitive tape.
- 04 **internal wall finish 1:**
make good and clean existing interior walls, new wall finishes to match existing
- 05 **internal wall finish 2:**
2100mm high ceramic tile to later specification with plaster and paint to ceiling.
- 06 **external wall finish 1:**
make good and clean existing walls, al bricked up areas to match existing finishes.
- 07 **external wall finish 2:**
make good and clean existing brickwork, new brickwork to match existing.
- 08 **ceiling specification:**
WISA' or similar SABS approved 12mm THK Marine ply-wood with Birch veneer finish of 12,5x2,75m Boards as per Manufacturers specs & details. fixed in line with roof slope directly underneath insulation.
- 09 **ceiling insulation (below roof sheeting):**
Sisalation: Sheeting & purlins to have fixed Laminated aluminium, Sisalation®410 Reflective Foil insulation with reinforced with fiberglass & flame retardant additives as per Manufacturers specifications.
- 10 **slab soffit:**
Slab soffit to be finished with 1:5 cement/sandplaster on splashcoat to concrete, finished smooth with timber trowel. Paint to finish.
- 11 **new floor surface beds:**
concrete surface bed to sizes shown with ref 193 mesh on 250 micron DPC on 20mm sand blinding on fill compacted in 150mm layers to 93% MOD AASHTO. fill to be treated with ant and termite poison to comply to SANS standards.
- 12 **existing floor surface beds:**
existing concrete surface beds to be inspected by structural engineer. all needed repairwork to be done according to engineers specifications if required.
- 13 **new foundation footings:**
concrete foundation strip footings to sizes shown on foundation plan. all to engineers specifications.
- 14 **existing foundation footings:**
existing concrete foundation strip footings to be inspected by structural engineer. all needed repairwork to be done according to engineers specifications if required.
- 15 **slab waterproofing:**
One layer Derbigum SP4 waterproofing membrane, with 75mm side laps and 100mm end laps, sealed to primed surface to falls and crossfalls by 'torchfusion' finished with two coats Roofcote bituminous aluminum paint. Waterproofing to be installed by an Approved Derbigum Contractor under a ten year guarantee.

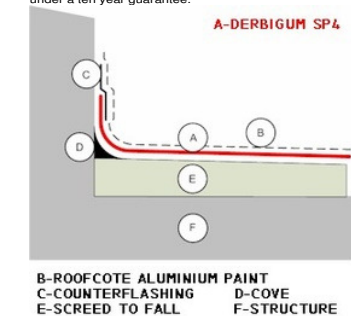

- 17 **roof sheeting:**
Global Roofing Solutions 0,80mm thick 762mm cover Corrugated profile Z275 spelter ISO550 galvanised steel roof sheeting, fixed to steel existing purlins using Hex Flange Head + EPDM Seal self drilling No. 3 drill point, No. 12-14 x 53mm long fasteners. Purlin fixed to first, fourth and eighth crest of each sheet and at all crests at sheet ends, all in accordance with the manufacturer's specifications.
All existing steel truss sections to be painted with Plascon white enamel.
- 18 **ceiling insulation (above ceiling):**
'Iso-Therm' : insulation of heavy duty light weight cellulose fibre insulation, manufactured in accordance with SANS 1381-6:1994, evenly laid/blown to a depth of min135mm THK in roof spacings above ceilings. All work according to SABS Standards & Regulations.

Scale 1:100
Taung Skull & Mine Museum - groundfloor plan

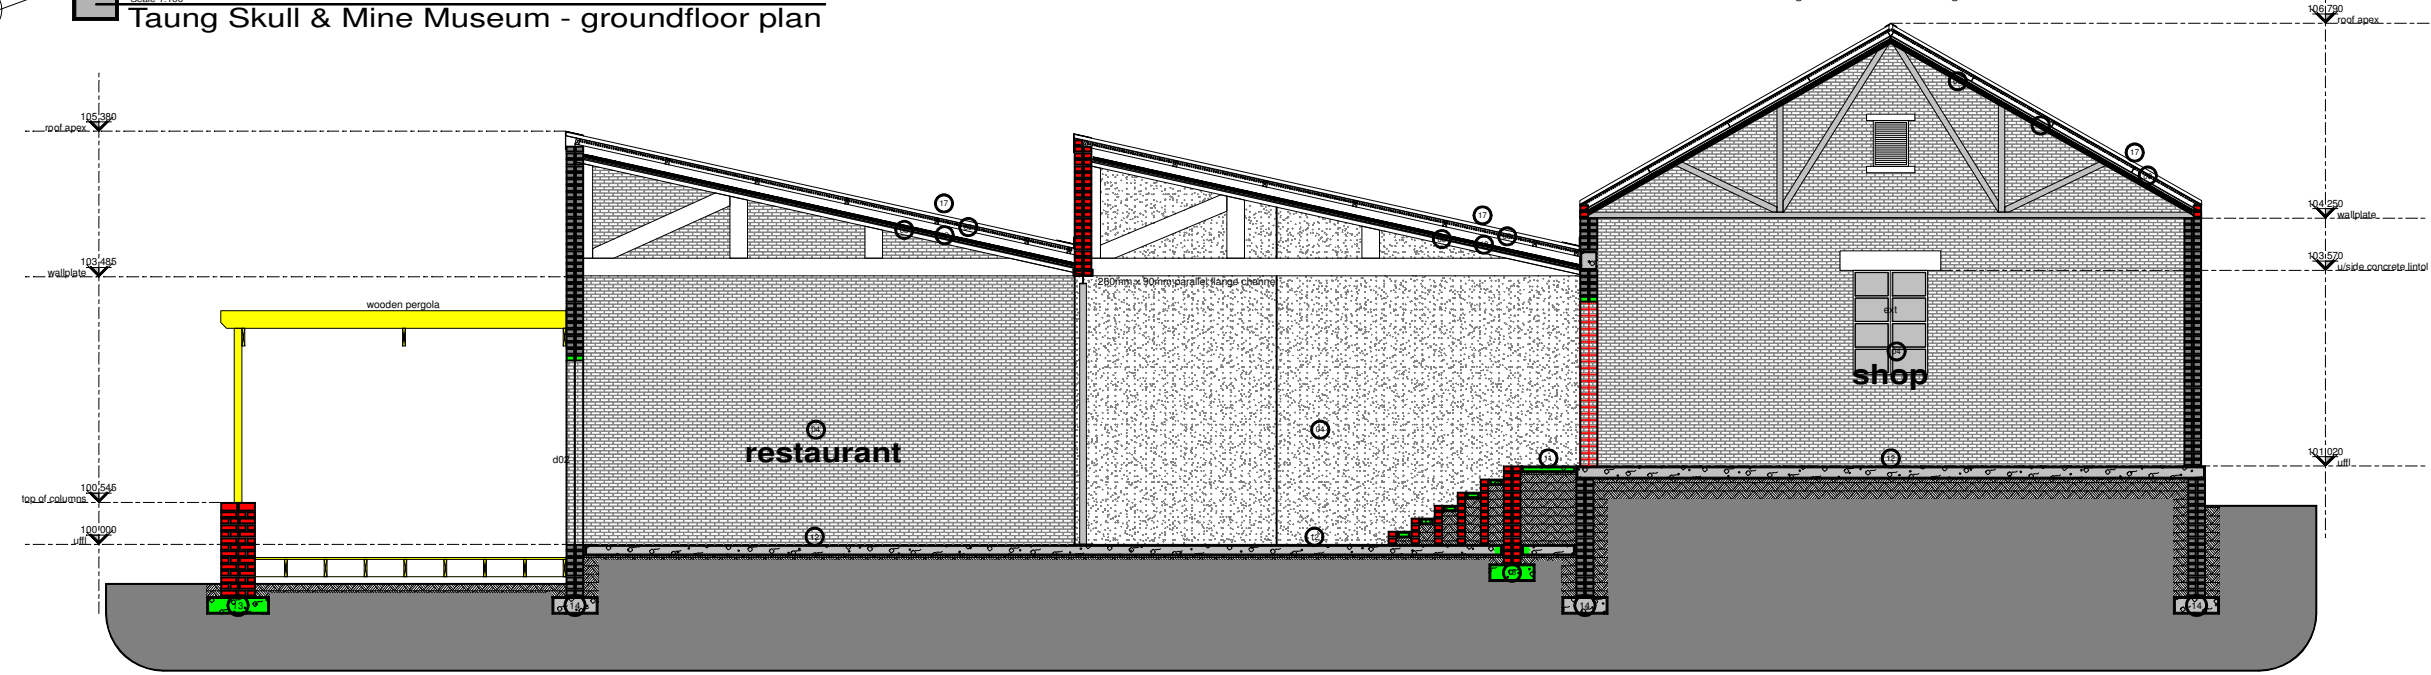

Scale 1:50
Taung Skull & Mine Museum - section a-a

COPYRIGHT RESERVED
COPYRIGHT NOTICE
COPYRIGHT @ 2017 - Bakopane Architects cc
Copyright subsists in this drawing. The person or entity whose name appears in the title block of this drawing, is hereby granted a non-exclusive licence to use, display, print and/or reproduce this drawing to the extent necessary to carry out and complete the project described in the title block of this drawing. This licence in respect of the copyright is expressly limited as aforesaid and the person and / or entity referred to above shall not be entitled to grant sub-licences in respect of the copyright in this drawing to any other entity. This licence confers no ownership rights in the copyright vesting in the drawing and this drawing and the copyright subsisting therein will, at all times, remain the property of Bakopane Architects cc. Any unauthorised reproduction, publication, transmission, adaption and/or inclusion of this drawing in a cinematograph film or television broadcast is an act of copyright infringement which will render the doer of the act liable for civil law copyright infringement and may in certain circumstances render the doer liable to criminal prosecution. Requests and enquiries concerning this drawing and the rights subsisting therein should be addressed to the copyright owner.

No.	Date:	Notes:	Drawn:
Rev 00	28/06/17	working drawing started	cw

- GENERAL NOTES:**
1. Check all measurements, levels and details on site before commencement with work.
 2. Refer any discrepancies to architect
 3. All work to be done in accordance with SANS-10400
 4. Nothing to be scaled from drawing; request measurement from architect
 5. Architect's & engineer's drawings to be read together
 6. Drawing to be used for intention as mentioned in Drawing description.



CLIENTS SIGNATURE:



DEPARTMENT'S SIGNATURE:



PRINCIPAL AGENT SIGNATURE:

bakopane architects

Practise Building
23 Corridor Crescent,
Rooiwal Business Park,
Ben Fleur Ed 11

Post: P.O. Box 543, Erasmussen, 1035
Tel: 013 633 6201 / 033 6355
Fax: 086 567 5564
Email: bakopane@gmail.com

ARCHITECTS SIGNATURE:

PROPOSED ALTERATIONS & ADDITIONS TO TAUNG SKULL HERITAGE SITE FOR NORTH-WEST RURAL, ENVIRONMENTAL & AGRICULTURE DEPARTMENT PROVINCE OF NORTH-WEST

DRAWING DESCRIPTION:		ORIGINAL	A1
restaurant: groundfloorplan section a-a		DRG. SIZE	A1
		SCALE: 1/100	
		REV.	0