

SECTION A - A **SCALE 1:100** 

existing roof structures to be inspected by the structural engineer new ibr chromodek and translucent roof sheeting new concrete roof tiles to be laid on new timber to be laid on new steel purlins as per engineers battens 600cc on new timber trusses to match specifications existing roof as per engineers spec new suspended ceiling as per finishing schedule existing BIC to be made good as per scope of external facebrick to be plastered and painted to works. ironmongery to be removed and replaced **ROOM 116 ROOM 117 ROOM 105** PASSAGE match existing paint as per scope of works PLANT ROOM with new windows to be new aluminium windows to match existing as per removed and window schedule existing gate to be removed and replaced with fire replaced with new door. opening to be bricked up to match existing new terracotta window cills to be removed and DOUBLE VOLUME CASH HALL facebrick existing slab existing slab replaced with new to match existing as per scope of works PASSAGE PASSAGE ROOM 20 ROOM 22 new gutters and rain water down pipes as per new aluminium windows to match existing as per PLANT ROOM scope of works window schedule existing steel burglar bars to be removed. opening new terracotta window cills to be removed and to be bricked up to match existing facebrick replaced with new to match existing as per scope of new teller to be on a 170 high concrete platform 1:12 concrete ramp with 1000 high glass balustrades existing timber floor to be removed and filled and existing foundations existing foundations existing foundations well compacted for concrete slab, all to engineer's recommendations and specification. full bodied

> SECTION B - B **SCALE 1:100**

porcelain floor tiles to replace timber flooring

**REVISION STATUS** Description By Checked **GENERAL NOTES:** 1. CHECK ALL DIMENSIONS AND LEVELS BEFORE

COMMENCING ANY WORK.

- 2. DO NOT SCALE FROM THE DRAWINGS.
- 3. ANY QUERIES TO BE BROUGHT TO THE ARCHITECT'S ATTENTION.
- 4. ALL STRUCTURAL STEEL, CONCRETE STRENGTH AND TIMBER SPECIFICATION ARE TO BE IN ACCORDANCE WITH ENGINEER'S DETAILS.
- 5. DRAWINGS FOR INFORMATION PURPOSES ONLY

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Tel: 012 664 6577 Email: arinaon@muteo.co.za

PROJECT NAME: MLB BUILDING

ROOF REPLACEMENT AND RENOVATIONS TO THE MLB BUILDING

ERF NO : ERF 106 OF DURBAN & 107 OF DURBAN

DRAWING TITLE: SECTIONS

PROJECT:

MLB BUILDING

DRAWN BY PP CHECKED BY NS/ SM/ RJM DATE 02 SEPTEMBER 2022 LATEST ISSUE 02 SEPTEMBER 2022

SCALE AS SHOWN

> DWG NO. REV NO. MLB.DD.05

R.00

| WINDOW SCHEDULE       |   |   |  |   |   |   |   |   |   |
|-----------------------|---|---|--|---|---|---|---|---|---|
|                       | W1  | W2  | W3   | W4  | W5  | W6  | W7  | W8  | W9  |
| U/S OF LINTEL         | <u>, 1000 ,</u>   | * 800 *   | * 1000 *   | ,500,   | , 1000 <sub>j</sub> .   | <u>, 1550</u> ,   | <u>* 1000 *</u>   | <u>* 1100 *</u>   | * 680 *   |
| FINISHED LEVEL        | 2400  | 1200  | 1100   | 0011  | 1000  | 2500  | 006   | 1360  |   |
|                       |   |   |  |   |   |   |   |   |   |
|                       |   |   |  |   | FIXED   | FIXED   |   |   |   |
| WINDOW NUMBER         | W1  | W2  | W3   | W4  | W5  | W6  | W7  | W8  | W9  |
| QUANTITY              | 71  | 4   | 10   | 4   | 2   | 2   | 1   | 17  | 13  |
| WINDOW<br>DESCRIPTION | 75 MM (26B) CREALCO CASEMENT<br>WINDOW POWDER COATING BLACK TO<br>MATCH EXISTING WINDOWS AS PER<br>AAAMSA REQUIREMENTS  | 75 MM (26B) CREALCO CASEMENT<br>WINDOW POWDER COATING<br>BRONZE TO MATCH EXISTING<br>WINDOWS AS PER AAAMSA<br>REQUIREMENTS  | 75 MM (26B) CREALCO CASEMENT<br>WINDOW POWDER COATING<br>BRONZE TO MATCH EXISTING<br>WINDOWS AS PER AAAMSA<br>REQUIREMENTS   | 75 MM (26B) CREALCO CASEMENT<br>WINDOW POWDER COATING<br>BRONZE TO MATCH EXISTING<br>WINDOWS AS PER AAAMSA<br>REQUIREMENTS  | 75 MM (26B) CREALCO CASEMENT<br>WINDOW POWDER COATING<br>BRONZE TO MATCH EXISTING<br>WINDOWS AS PER AAAMSA<br>REQUIREMENTS  | 75 MM (26B) CREALCO CASEMENT<br>WINDOW POWDER COATING<br>BRONZE TO MATCH EXISTING<br>WINDOWS AS PER AAAMSA<br>REQUIREMENTS  | 75 MM (26B) CREALCO CASEMENT WINDOW POWDER COATING BRONZE TO MATCH EXISTING WINDOWS AS PER AAAMSA REQUIREMENTS  | 75 MM (26B) CREALCO CASEMENT<br>WINDOW POWDER COATING<br>BRONZE TO MATCH EXISTING<br>WINDOWS AS PER AAAMSA<br>REQUIREMENTS  | 75 MM (26B) CREALCO CASEMENT<br>WINDOW POWDER COATING<br>BRONZE TO MATCH EXISTING<br>WINDOWS AS PER AAAMSA<br>REQUIREMENTS  |
| FRAME FINISH          | BRONZE POWDER COATING<br>ACCORDING TO AAAMSA  | BRONZE POWDER COATING<br>ACCORDING TO AAAMSA  | BRONZE POWDER COATING<br>ACCORDING TO AAAMSA   | BRONZE POWDER COATING<br>ACCORDING TO AAAMSA  | BRONZE POWDER COATING<br>ACCORDING TO AAAMSA  | BRONZE POWDER COATING<br>ACCORDING TO AAAMSA  | BRONZE POWDER COATING<br>ACCORDING TO AAAMSA  | BRONZE POWDER COATING<br>ACCORDING TO AAAMSA  | BRONZE POWDER COATING<br>ACCORDING TO AAAMSA  |
| GLASS                 | 4mm CLEAR SINGLE LOW E TOUGHENED<br>SAFETY GLASS WITH A 5.73 U-VALUE AND<br>0.66 SHGC RATING AS SUPPLIED<br>BY MANUFACTURER.  | 4mm CLEAR SINGLE LOW E TOUGHENED SAFETY GLASS WITH A 5.73 U-VALUE AND 0.66 SHGC RATING AS SUPPLIED BY MANUFACTURER.   | 4mm OBSCURE SINGLE LOW E TOUGHENED SAFETY GLASS WITH A 5.73 U-VALUE AND 0.66 SHGC RATING AS SUPPLIED   | 4mm CLEAR SINGLE LOW E TOUGHENED SAFETY GLASS WITH A 5.73 U-VALUE AND 0.66 SHGC RATING AS SUPPLIED BY MANUFACTURER.   | 4mm CLEAR SINGLE LOW E TOUGHENED<br>SAFETY GLASS WITH A 5.73 U-VALUE AND<br>0.66 SHGC RATING AS SUPPLIED<br>BY MANUFACTURER.  | 4mm CLEAR SINGLE LOW E TOUGHENED SAFETY GLASS WITH A 5.73 U-VALUE AND 0.66 SHGC RATING AS SUPPLIED BY MANUFACTURER.   | 4mm CLEAR SINGLE LOW E TOUGHENED<br>SAFETY GLASS WITH A 5.73 U-VALUE AND<br>0.66 SHGC RATING AS SUPPLIED<br>BY MANUFACTURER.  | 4mm CLEAR SINGLE LOW E TOUGHENED SAFETY GLASS WITH A 5.73 U-VALUE AND 0.66 SHGC RATING AS SUPPLIED BY MANUFACTURER.   | 4mm CLEAR SINGLE LOW E TOUGHENED<br>SAFETY GLASS WITH A 5.73 U-VALUE AND<br>0.66 SHGC RATING AS SUPPLIED<br>BY MANUFACTURER.  |
| GLAZING               | GLAZING TO COMPLY WITH PART 'N' OF NATIONAL BUILDING REGULATIONS, AAAMSA GENERAL SPECIFICATIONS, SANS 10137 & SANS 1263 PART 1 & 2. GLAZING MANUFACTURED AND INSTALLED BY ONLY A RECOGNIZED MEMBER OF S.A. GLASS GLAZING ASSOCIATION. | GLAZING TO COMPLY WITH PART 'N' OF NATIONAL BUILDING REGULATIONS, AAAMSA GENERAL SPECIFICATIONS, SANS 10137 & SANS 1263 PART 1 & 2. GLAZING MANUFACTURED AND INSTALLED BY ONLY A RECOGNIZED MEMBER OF S.A. GLASS GLAZING ASSOCIATION. | BY MANUFACTURER. GLAZING TO COMPLY WITH PART 'N' OF NATIONAL BUILDING REGULATIONS, AAAMSA GENERAL SPECIFICATIONS, SANS 10137 & SANS 1263 PART 1 & 2. GLAZING MANUFACTURED AND INSTALLED BY ONLY A RECOGNIZED MEMBER OF S.A. GLASS GLAZING ASSOCIATION. | GLAZING TO COMPLY WITH PART 'N' OF NATIONAL BUILDING REGULATIONS, AAAMSA GENERAL SPECIFICATIONS, SANS 10137 & SANS 1263 PART 1 & 2. GLAZING MANUFACTURED AND INSTALLED BY ONLY A RECOGNIZED MEMBER OF S.A. GLASS GLAZING ASSOCIATION. | GLAZING TO COMPLY WITH PART 'N' OF NATIONAL BUILDING REGULATIONS, AAAMSA GENERAL SPECIFICATIONS, 5ANS 10137 & SANS 1263 PART 1 & 2. GLAZING MANUFACTURED AND INSTALLED BY ONLY A RECOGNIZED MEMBER OF S.A. GLASS GLAZING ASSOCIATION. | GLAZING TO COMPLY WITH PART 'N' OF NATIONAL BUILDING REGULATIONS, AAAMSA GENERAL SPECIFICATIONS, SANS 10137 & SANS 1263 PART 1 & 2. GLAZING MANUFACTURED AND INSTALLED BY ONLY A RECOGNIZED MEMBER OF S.A. GLASS GLAZING ASSOCIATION. | GLAZING TO COMPLY WITH PART 'N' OF NATIONAL BUILDING REGULATIONS, AAAMSA GENERAL SPECIFICATIONS, SANS 10137 & SANS 1263 PART 1 & 2. GLAZING MANUFACTURED AND INSTALLED BY ONLY A RECOGNIZED MEMBER OF S.A. GLASS GLAZING ASSOCIATION. | GLAZING TO COMPLY WITH PART 'N' OF NATIONAL BUILDING REGULATIONS, AAAMSA GENERAL SPECIFICATIONS, SANS 10137 & SANS 1263 PART 1 & 2. GLAZING MANUFACTURED AND INSTALLED BY ONLY A RECOGNIZED MEMBER OF S.A. GLASS GLAZING ASSOCIATION. | GLAZING TO COMPLY WITH PART 'N' OF NATIONAL BUILDING REGULATIONS, AAAMSA GENERAL SPECIFICATIONS, SANS 10137 & SANS 1263 PART 1 & 2. GLAZING MANUFACTURED AND INSTALLED BY ONLY A RECOGNIZED MEMBER OF S.A. GLASS GLAZING ASSOCIATION. |
| SECURITY              |   | -   | -  | -   | -   | -   | -   | -   | -   |
| FITTINGS              | AS PER MANUFACTURER'S DETAIL  | AS PER MANUFACTURER'S DETAIL  | AS PER MANUFACTURER'S DETAIL   | AS PER MANUFACTURER'S DETAIL  | AS PER MANUFACTURER'S DETAIL  | AS PER MANUFACTURER'S DETAIL  | AS PER MANUFACTURER'S DETAIL  | AS PER MANUFACTURER'S DETAIL  | AS PER MANUFACTURER'S DETAIL  |
| CILLS - EXTERNAL      | BRICK-ON-EDGE FACEBRICK<br>WINDOW CILL AT REQUIRED<br>ANGLE.  | BRICK-ON-EDGE FACEBRICK<br>WINDOW CILL AT REQUIRED<br>ANGLE.  | BRICK-ON-EDGE FACEBRICK<br>WINDOW CILL AT REQUIRED<br>ANGLE.   | BRICK-ON-EDGE FACEBRICK<br>WINDOW CILL AT REQUIRED<br>ANGLE.  | N/A   | BRICK-ON-EDGE FACEBRICK<br>WINDOW CILL AT REQUIRED<br>ANGLE.  |
| WINDOW BLINDS         | PURPOSE MADE BLINDS AS PER<br>CLIENT'S APPROVAL   | -   | -  | -   | -   | -   | -   | PURPOSE MADE BLINDS AS PER<br>CLIENT'S APPROVAL   | -   |

|                       | W10   | W11   | W12   | W13   | W14   | W15   | W16   | W17   |
|-----------------------|---|---|---|---|---|---|---|---|
| U/S OF LINTEL         | * 1000 *  | <u>, 1000 , </u>  | * 1200 *  | <u>,600,</u>  | <u>, 1100 ,</u>   | <u>* 2100</u> *   | † 2100<br>†   | <u>* 2250</u>   |
| FINISHED LEVEL        | 2400  | 2400  | 1000  |   | 1600  | 1850  | 2150  | 1785  |
| WINDOW NUMBER         | W10   |   | W12   | W13   | W14   | W15   | W16   | W17   |
| QUANTITY              | 16  | 2   | 4   | 2   | 8   | 6   | 6   | 11  |
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| SECURITY              | -   | -   |   | -   | -   | -   | -   | -   |
| FITTINGS              | AS PER MANUFACTURER'S DETAIL  |
| CILLS - EXTERNAL      | BRICK-ON-EDGE FACEBRICK<br>WINDOW CILL AT REQUIRED<br>ANGLE.  |
| WINDOW BLINDS         | PURPOSE MADE BLINDS AS PER CLIENT'S APPROVAL  | PURPOSE MADE BLINDS AS PER  | PURPOSE MADE BLINDS AS PER<br>CLIENT'S APPROVAL   | PURPOSE MADE BLINDS AS PER<br>CLIENT'S APPROVAL   | PURPOSE MADE BLINDS AS PER<br>CLIENT'S APPROVAL   | -   | -   | _   |

REVISION STATUS By Checked Description

## **GENERAL NOTES:**

- CHECK ALL DIMENSIONS AND LEVELS BEFORE COMMENCING ANY WORK.
- 2. DO NOT SCALE FROM THE DRAWINGS.

- 3. ANY QUERIES TO BE BROUGHT TO THE ARCHITECT'S ATTENTION.

  4. ALL STRUCTURAL STEEL, CONCRETE STRENGTH AND TIMBER SPECIFICATION ARE TO BE IN ACCORDANCE WITH ENGINEER'S DETAILS.

  5. DRAWINGS FOR INFORMATION PURPOSES ONLY

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Public Works
Province of KWAZULU-NATAL

Tel: 060 554 3053 Email: nqobile.cele@kznworks.gov.za

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Tel: 031 207 1340

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MECHANICAL ENGINEER

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Tel: 012 664 6577 Email: arinaon@muteo.co.za

PROJECT NAME: MLB BUILDING

ROOF REPLACEMENT AND RENOVATIONS TO THE MLB BUILDING

ERF NO : ERF 106 OF DURBAN & 107 OF DURBAN


DRAWING TITLE: WINDOW SCHEDULE

| - 1 |              |                |
|-----|--------------|----------------|
|     | DRAWN BY     | PP             |
|     | CHECKED BY   | NS/TRW         |
|     | DATE         | 30 AUGUST 2022 |
|     | LATEST ISSUE | 30 AUGUST 2022 |
|     | SCALE        | AS SHOWN       |
| -   |              |                |


| PROJECT:     | DWG NO.   | REV NO. |
|--------------|-----------|---------|
| MLB BUILDING | MLB.DD.14 | R.00    |



NORTH EAST ELEVATION **SCALE 1:100** 

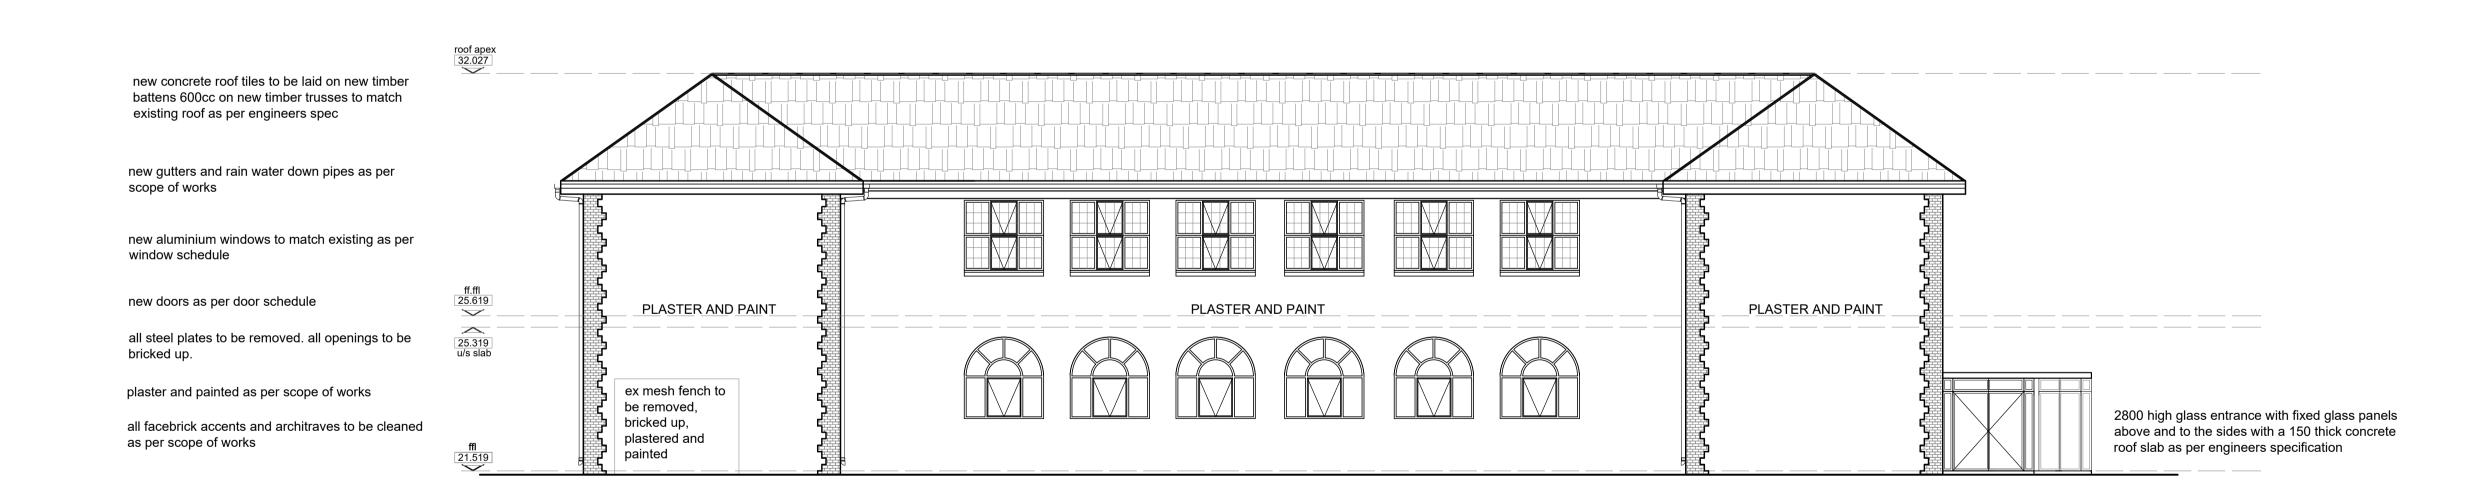

SOUTH WEST ELEVATION **SCALE 1:100** 

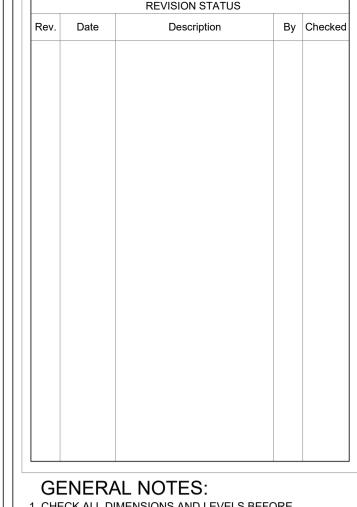

1. CHECK ALL DIMENSIONS AND LEVELS BEFORE COMMENCING ANY WORK.

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5. DRAWINGS FOR INFORMATION PURPOSES ONLY

The Department of Public Works

455A Jan Smuts Highway Mayville

Department:
Public Works
PROVINCE OF KWAZULU-NATAL

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PROJECT NAME: MLB BUILDING


ROOF REPLACEMENT AND RENOVATIONS TO THE MLB BUILDING

ERF NO : ERF 106 OF DURBAN & 107 OF DURBAN

DRAWING TITLE: ELEVATIONS

| PRAWN BY    | PP                |
|-------------|-------------------|
| CHECKED BY  | NS/ TRW/ RJM      |
| DATE        | 02 SEPTEMBER 2022 |
| ATEST ISSUE | 02 SEPTEMBER 2022 |
| CALE        | AS SHOWN          |
|             |                   |

PROJECT: DWG NO. REV NO. MLB BUILDING MLB.DD.06 R.00

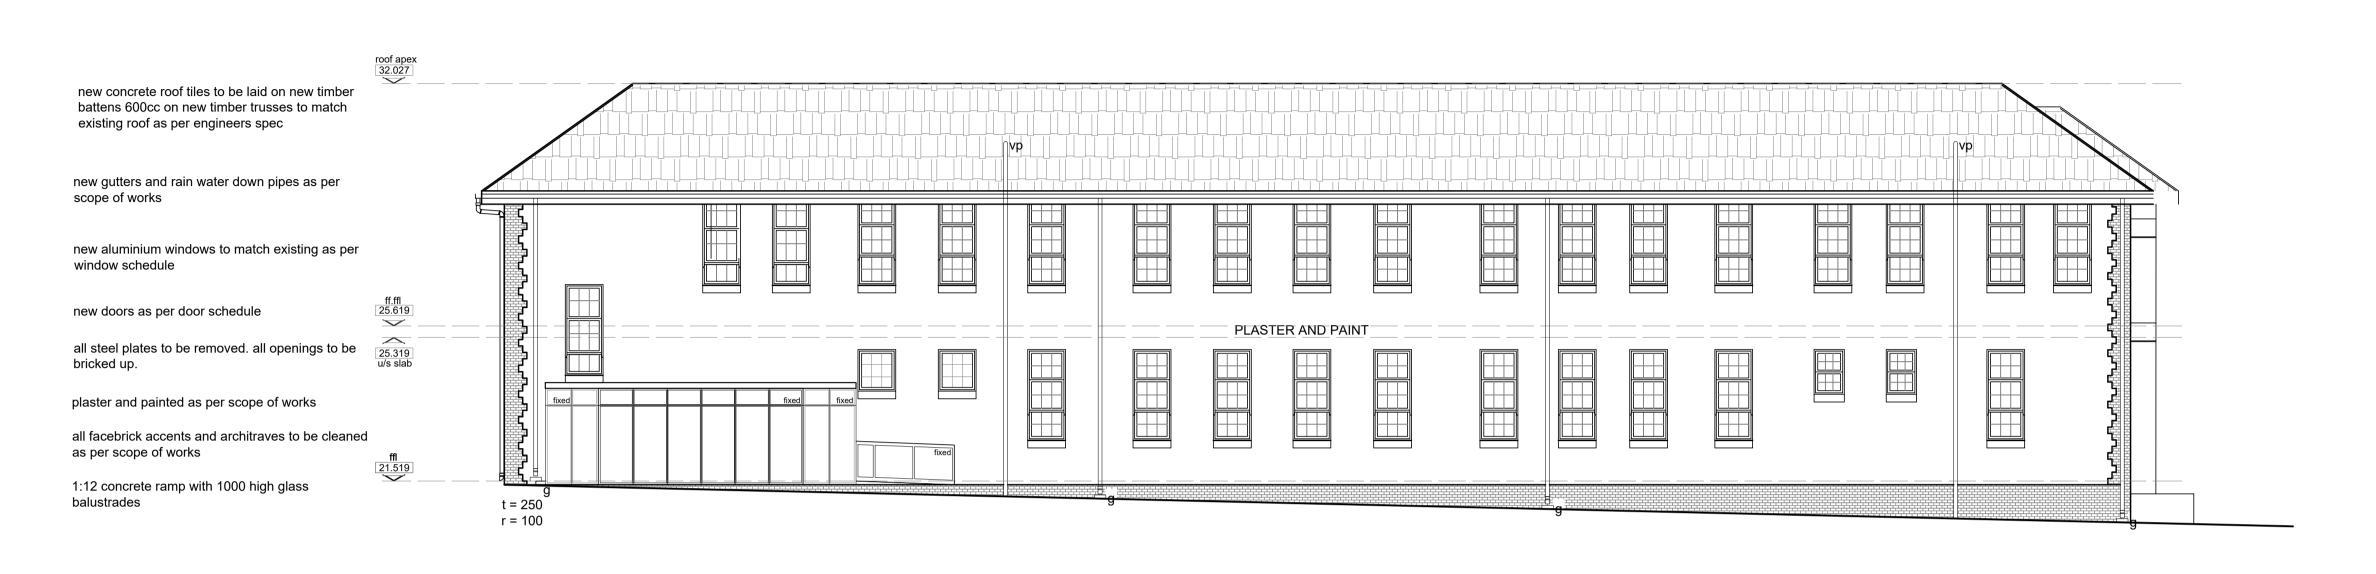

## SOUTH EAST ELEVATION SCALE 1:100



NORTH WEST ELEVATION

**SCALE 1:100** 

By Checked **GENERAL NOTES:** 1. CHECK ALL DIMENSIONS AND LEVELS BEFORE COMMENCING ANY WORK.

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PROVINCE OF KWAZULU-NATAL

A S S O C I A T E S ARCHITECTS

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PROJECT NAME: MLB BUILDING

ROOF REPLACEMENT AND RENOVATIONS TO THE MLB BUILDING

ERF NO : ERF 106 OF DURBAN & 107 OF DURBAN

DRAWING TITLE: ELEVATIONS

DRAWN BY CHECKED BY NS/ TRW/ RJM DATE 02 SEPTEMBER 2022 LATEST ISSUE 02 SEPTEMBER 2022 SCALE AS SHOWN

PROJ. NO: DWG NO. REV NO.

MLB BUILDING MLB.DD.07 R.00

#### PORTAL FRAME

- Sheeting and purlins to be removed and replaced with new.
- Engineer to advise on existing steel
- Timber beams are to be removed and replaced to match existing.
- Ceilings are to be removed and replaced with SUSPENDED CEILING BOARDS nailed to 38 x 38mm timber brandering at max 400mm centers with cretestone skimplaster finish and with tape-channel cover strips finished with 1 x undercoat and 2 x coats Plascon Professional Superior Low Sheen water based paint. Applied strictly as per manufacturer's instructions. Engineer to advise.

#### **ROOF NOTES**

- Existing roof sheeting and ridging to be removed and replaced with 0.58 mm thick galvanized corrugated profile roof sheeting, fixed with intermediate timber purlins at 1100mm centers. Skew nails to truss. Ridge and eaves purlins at 900 centers, with 12 x 45mm class 3 timber self drilling screws. Sheets to be fixed with class 3 fasteners 3 per sheet per purlin with 65 mm Tex or Top Speed screws as per manufacturers specifications.
- 0.58mm corrugated ridge capping, cranked to suit profile, fixed to sheeting and purlin by dry screws as per manufacturers specifications.
- New fibre cement barge boards size 250 x 80 x 12mm, fixed to 38 x 38mm trimmer batten and purlin twice screwed with 12 x 40mm brass countersunk screws with aluminum h-profile barge board joiners between boards and at roof apex. Apply 3 coats contractors white pva.
- New 225 x 12mm fibre cement fascia boards countersunk heads to 38 x 38 soffit nailed to side of rafter. Finish with 3 coats contractors white pva.
- Existing purlins to be removed and replaced with SA pine 75mm x 50mm timber purlins at 1100mm cc to ridge and 12 x 45mm class 3 timber. Sheets to be fixed with 3 skew nails per sheet per purlin. All with manufacturers recommendation.
- Existing concrete roof tiles to be removed, cleaned and stored on site to be reused. to be fixed with tile nails on to 38 x 38mm s.a.pine purlins @ max. 320mm c/c battens, on sabs approved underlay of 400microns, on 152 x 38mm s.a. pine trusses @ max 760mm c/c at 26 degree slope. tiling and fixing to comply with sabs 062 :1991 code of practice, and must be re-installed according manufactures specifications.
- Existing ridge & hip tiles to be removed, cleaned and stored on site to be reused. all bedding mortar for ridges and hips must consist of 3 parts clean plaster sand and 1 part portland cement tinted to the colour of the roof.
- Existing trusses to be removed and replaced with 152 x 38mm s.a. pine factory manufactured trusses similar or equal to gangnail trusses at max.760mm centres fixed, leveled and aligned on 114 x 38mm s.a. pine wall plate fixed on wall by means of 4mm ø galvanised wire, double winded, built into brickwork for min 5 brick coarses

- below wallplate level. trusses to be designed and certified by a registered engineer, and a engineer's certificate must be issued after installation.
- 6mm thick fibre cement ceiling nailed with 32 x 2,5mm nails at 150mm centres, onto 38 x 38mm s.a. pine battens @ max. 450mm centres. boards to be joined with metal h-strips according to manufacturers specifications. install 75 x 16mm hardwood cornice with plug & wood screws, stop sand and prepare for painting as per paint specification. refer to finishing schedule.
- 6mm thick fibre cement ceiling screwed with 25 x 3,5mm screws onto 38 x 50mm s.a. pine battens @ max. 450mm centres. apply joint-plaster tape "rhinotape' on joints. plaster with a 3-6mm coat of rhinolite skim plaster applied as per manufacturers instructions.
- 114 x 38mm s.a. pine wall plate leveled on brickwork and fixed onto walls by means of 4mm ø x 300mm galvanised built into wall min. five bricklayers.
- 225 x 12mm fibre cement fascia boards with aluminium h-profile fascia joiners, drill & fixed to ends of trusses with 2 x 40mm copper screws. fascia boards to be painted with one universal undercoat and two coats eggshell enamel.
- cornice moulding by 'dynamic artistic solutions' - colonial moulding. installed with glue against ceiling and wall,according to manufactuers specifications.
- cement mortar beam filling finished neatly and smooth below tiles.
- treat all exposed wood at roof overhang with carbolinium, or paint with primer and two coats enamel paint, before installing roof covering and underlay.
- Roof trusses to be inspected and to be removed and replaced as per Engineers recommendations.
- existing cornices to be removed and replaced with new 75mm cove cornice to match existing
- existing ceiling boards to be removed and replaced with 6.4mm gypsum board nailed to 38 x 38mm timber brandering at max 400mm centers with cretestone skimplaster finish and with tape-channel cover strips finished with 1 x undercoat and 2 x coats Plascon Professional Superior Low Sheen water based paint. Applied strictly as per manufacturer's instructions.

## WALLS

- Prepare cracks to plastered walls as per engineers specifications, apply one coat approved primer, repair defects with approved spot primer and two coats premium washable and stain resistant 100% acrylic emulsion. Colours of undercoat to match finishing coat but with enough difference to be able to distinguish between the two coats.
   Prepare colour sample of finishing coats before any bulk paint is to purchased.
   Colour to be approved by Architect.
- Existing partition walls to be plastered and painted on both sides. Paint as per finishing schedules.
- All external cills to be cleaned and painted.
- All internal cills to be 12mm fibre cement to be screwed to brickwork.
- External face brick to be assessed for

quality. If in good condition the face brick is to be cleaned non-abrasively with non-harsh cleaning chemicals, repointed, and sealed with a matt finish brick sealer. A sample of the refurbished wall is to be provided for approval.

#### **FLOORS**

- Existing floor finish to be stripped and replaced with full bodied 10mm thick 600x600 porcelain tile. with 3 PEI rating fixed to internal floor screed with rapid setting tile adhesive mixed with bonding liquid in lieu of water on concrete surface bed, and 3 mm joints continuous in both directions, jointed and flush pointed SABS approved tile grout.
- Existing carpets to be removed using adhesive remover.
- Porcelain floor tile skirting, 100mm high with a 24 hour adhesive solution to be plastered surfaces above floor tiles. Tiles to have 3mm joints. sealed joints between skirting tiles and floor tiles with silicone sealant.
- Aluminum threshold expansion filler to manufactures specification.
- Existing epoxy flooring to be stripped and redone as per engineers spec
- Timber flooring to be removed. void to to be filled G5 material and compacted as per engineers detail and replaced with porcelain tiles as per finishing schedule.

#### **WINDOWS**

- All timber windows to be removed and replaced as per window schedule.
- Bricks demolished for new window openings are to be carefully removed, cleaned and reused in patchwork. If existing bricks are unsalvageable a sample brick to match existing, to be provided for approval.
- See attached window schedule for burglar guard details.

## DOORS

- All damaged internal and external doors to be removed and replaced as per door schedule.
- All good internal and external doors to be sanded and varnished as per door schedule.
- All partition internal and external doors to be removed and replaced as per door schedule.

## PLUMBING AND FITTINGS

- All existing sanitary ware is to be removed and replaced with new as indicated in the sanitary Schedule.
- Existing drainage and pipe work systems to be flushed as per engineers recommendations.

## RAIN WATER GOODS

 New 200 x 250mm extruded aluminum seamless gutters fixed to fascia boards by 2 no. 25mm brass screws into fascia and soffit, including all necessary fittings as per manufacturers recommendation and to comply with SANS 11:2007. Fixed to 12 x 225mm fibre cement fascia boards with a slight slope towards the 200mm Ø aluminum downpipe which is fixed to the walls with aluminum 6 no. downpipe clips with the specified aluminium shoe as per engineers report

#### AIR CONDITIONING

 existing air conditioning units are to be remove and replaced with new as per engineers recommendation

#### **BALUSTRADES**

- to be removed and replaced with windows where shown
- remaining balustrades to be inspected and made good.
- External ramp balustrade to comply with SANS 10400 Part M

#### GATE:

- All gates are to be inspected and made good.
- All hinges to be removed and replaced.

#### **FENCING**

- Steel fencing to be inspected and made good, where necessary
- Wire mesh fencing to be inspected and made good, where necessary

#### RUST

 Steel to be sprayed or painted with a rust dissolving solution directly onto the rusted area. Leave solution on rusted area for 15 to 30 minutes or until rust is dissolved. To be derusted with a wire brush, steel wool or sand paper. to be primed with a rust inhibitor primer and painted with a galvanised paint.

### GENERAL

- All structural elements and condition of building to be verified by engineer.
- All existing foundations, floor slabs and roof trusses to be verified by the engineer.
- If there are cracks to the existing floor prior to covering engineers to confirm.
- If there are cracks on the walls, this is to be remedied to engineer's recommendation and specification.
- All external services as per the relevant engineers drawings.
- All Fittings removed are to be assessed by Client for donation purposes.
- Turnstyle to be inspected by a specialist. Specialist to advise on condition; to be made good or removed and replaced
- All signage to be removed and stored on site. to be reinstalled as per clients specifications

## MECHANICAL

• Engineer to advise on Hydroboils

Rev. Date Description By Checked

REVISION STATUS

## GENERAL NOTES:

- 1. CHECK ALL DIMENSIONS AND LEVELS BEFORE COMMENCING ANY WORK.
- 2. DO NOT SCALE FROM THE DRAWINGS.
- 3. ANY QUERIES TO BE BROUGHT TO THE ARCHITECT'S ATTENTION.
  4. ALL STRUCTURAL STEEL, CONCRETE STRENGTH AND
- TIMBER SPECIFICATION ARE TO BE IN ACCORDANCE WITH ENGINEER'S DETAILS.
- 5. DRAWINGS FOR INFORMATION PURPOSES ONLY

CLIENT
The Department of Public Works

The Department of Public 455A Jan Smuts Highway Mayville Durban

4001

DETAIL DESIGN

public works

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Public Works
PROVINCE OF KWAZULU-NATA

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PROJECT NAME: MLB BUILDING

ROOF REPLACEMENT AND RENOVATIONS TO THE MLB BUILDING

ERF NO : ERF 106 OF DURBAN & 107 OF DURBAN

DRAWING TITLE: SCOPE OF WORKS

DRAWN BY

CHECKED BY

NS/ TRW/ RJM

DATE

02 SEPTEMBER 2022

LATEST ISSUE

02 SEPTEMBER 2022

SCALE


AS SHOWN

PROJ. NO : DWG NO. REV NO.

MLB BUILDING MLB.DD.13 R.00

| WINDOW SCH            | EDULE   |   |   |   |
|-----------------------|---|---|---|---|
| U/S OF LINTEL         | W18  11000  680   | W19 2100 1888   | W20  ***2100  ****2100  *****************   | W21   |
| FINISHED LEVEL        | FIXED   | FIXED   | FIXED   | ·<br>   |
|                       |   |   |   |   |
| WINDOW NUMBER         | W12   | W19   | W20   | W21   |
| QUANTITY              | 2   | 4   | 6   | 1   |
| WINDOW<br>DESCRIPTION | 75 MM (26B) CREALCO CASEMENT WINDOW POWDER COATING BRONZE TO MATCH EXISTING WINDOWS AS PER AAAMSA REQUIREMENTS  | 75 MM (26B) CREALCO CASEMENT<br>WINDOW POWDER COATING<br>BRONZE TO MATCH EXISTING<br>WINDOWS AS PER AAAMSA<br>REQUIREMENTS  | 75 MM (26B) CREALCO CASEMENT<br>WINDOW POWDER COATING<br>BRONZE TO MATCH EXISTING<br>WINDOWS AS PER AAAMSA<br>REQUIREMENTS  | 75 MM (26B) CREALCO CASEMENT<br>WINDOW POWDER COATING<br>BRONZE TO MATCH EXISTING<br>WINDOWS AS PER AAAMSA<br>REQUIREMENTS  |
| FRAME FINISH          | BRONZE POWDER COATING ACCORDING TO AAAMSA   | BRONZE POWDER COATING<br>ACCORDING TO AAAMSA  | BRONZE POWDER COATING<br>ACCORDING TO AAAMSA  | BRONZE POWDER COATING<br>ACCORDING TO AAAMSA  |
| GLASS                 | 4mm CLEAR SINGLE LOW E TOUGHENED SAFETY GLASS WITH A 5.73<br>U-VALUE AND 0.66 SHGC RATING AS SUPPLIED BY MANUFACTURER.  | 4mm CLEAR SINGLE LOW E TOUGHENED SAFETY GLASS WITH A 5.73 U-VALUE AND 0.66 SHGC RATING AS SUPPLIED BY MANUFACTURER.   | 4mm CLEAR SINGLE LOW E TOUGHENED SAFETY GLASS WITH A 5.73 U-VALUE AND 0.66 SHGC RATING AS SUPPLIED BY MANUFACTURER.   | 4mm CLEAR SINGLE LOW E TOUGHENED SAFETY GLASS WITH A 5.73 U-VALUE AND 0.66 SHGC RATING AS SUPPLIED BY MANUFACTURER.   |
| GLAZING               | GLAZING TO COMPLY WITH PART 'N' OF NATIONAL BUILDING REGULATIONS, AAAMSA GENERAL SPECIFICATIONS, SANS 10137 & SANS 1263 PART 1 & 2. GLAZING MANUFACTURED AND INSTALLED BY ONLY A RECOGNIZED MEMBER OF S.A. GLASS GLAZING ASSOCIATION. | GLAZING TO COMPLY WITH PART 'N' OF NATIONAL BUILDING REGULATIONS, AAAMSA GENERAL SPECIFICATIONS, SANS 10137 & SANS 1263 PART 1 & 2. GLAZING MANUFACTURED AND INSTALLED BY ONLY A RECOGNIZED MEMBER OF S.A. GLASS GLAZING ASSOCIATION. | GLAZING TO COMPLY WITH PART 'N' OF NATIONAL BUILDING REGULATIONS, AAAMSA GENERAL SPECIFICATIONS, SANS 10137 & SANS 1263 PART 1 & 2. GLAZING MANUFACTURED AND INSTALLED BY ONLY A RECOGNIZED MEMBER OF S.A. GLASS GLAZING ASSOCIATION. | GLAZING TO COMPLY WITH PART 'N' OF NATIONAL BUILDING REGULATIONS, AAAMSA GENERAL SPECIFICATIONS, SANS 10137 & SANS 1263 PART 1 & 2. GLAZING MANUFACTURED AND INSTALLED BY ONLY A RECOGNIZED MEMBER OF S.A. GLASS GLAZING ASSOCIATION. |
| SECURITY              | -   | -   | -   | -   |
| FITTINGS              | AS PER MANUFACTURER'S DETAIL  |
| CILLS - EXTERNAL      | -   | -   | BRICK-ON-EDGE FACEBRICK<br>WINDOW CILL AT REQUIRED<br>ANGLE.  | BRICK-ON-EDGE FACEBRICK<br>WINDOW CILL AT REQUIRED<br>ANGLE.  |
| WINDOW BLINDS         | -   | -   | -   | PURPOSE MADE BLINDS AS PER<br>CLIENT'S APPROVAL   |

DETAIL DESIGN

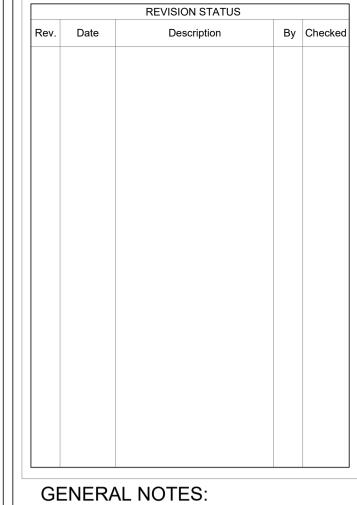

- CHECK ALL DIMENSIONS AND LEVELS BEFORE COMMENCING ANY WORK.
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  4. ALL STRUCTURAL STEEL, CONCRETE STRENGTH AND TIMBER SPECIFICATION ARE TO BE IN ACCORDANCE WITH ENGINEER'S DETAILS.

  5. DRAWINGS FOR INFORMATION PURPOSES ONLY

Mayville

Durban 4001

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Public works

Department:
Public Works
PROVINCE OF KWAZULU-NATAL

Tel: 060 554 3053 Email: nqobile.cele@kznworks.gov.za

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MECHANICAL ENGINEER

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PROJECT NAME: MLB BUILDING

ROOF REPLACEMENT AND RENOVATIONS TO THE MLB BUILDING

ERF NO : ERF 106 OF DURBAN & 107 OF DURBAN

DRAWING TITLE: WINDOW SCHEDULE

|     | DRAWN BY     | PP                |
|-----|--------------|-------------------|
|     | CHECKED BY   | NS/TRW            |
|     | DATE         | 02 SEPTEMBER 2022 |
|     | LATEST ISSUE | 02 SEPTEMBER 2022 |
|     | SCALE        | AS SHOWN          |
| - 1 |              | '                 |

| PROJECT:     | DWG NO.   | REV NO. |
|--------------|-----------|---------|
| MLB BUILDING | MLB.DD.15 | R.00    |