TECHNICAL SITE SURVEY ACCEPTANCE CERTIFICATE (TSSAC)

| a) Greenfield√ | b) Rooftop | c) 3 rd Party | d) MTN Existing (Antenna Upgrade) | e) DAS | |
|-------------------------------|------------|--------------------------|--|--------|--|
| f) Minor RF Upgrade g) Logica | | g) Logical | I Upgrade Only (Hardware must have previously been accepted by MTN Regional CPG) | | |

Tick the appropriate block

| Site Name | Zustersstroom | | | | | | |
|--|---------------|---------|--------------|----------------|-----------|-----|--------|
| Site ID | X100301 | | | Project Number | | | |
| Region (tick the appropriate block) | E Cape | Central | Gauteng S | Gauteng N | Northern√ | KZN | W Cape |
| Turnkey Contractor(tick the appropriate block) | Ericsson | | Huawei√ | | | ZTE | |

This is to certify that the following Network Element Stream has been surveyed according to the BTS Site Specification Document Number MTN SA TI/o1/1001 September 2014 Issue 10 Rev 1 and Transmission Specification Number MTN SA TI/o6/1001Tx Issue 6 rev 2, Civil Aviation requirements and all Municipal bylaws and regulations, whilst all security elements have been considered.

The following documents have been attached:

| Site Plan (if applicable) | 360 degree Panoramic Photos |
|---|-----------------------------|
| Tower Loading Application Form (Where additional/New Antennas have been added to existing MTN towers) | |

| Network Element Stream | Tick Applicable | BTS Type | Transmission Type (MW or Fibre) |
|---------------------------------|--------------------|------------------|------------------------------------|
| 2G Sectorisation (900/1800) | | | |
| 2G Capacity Upgrade | | | |
| 3G Capacity Upgrade | | THE !! " 15 JUL! | |
| 2G Macro Site | V | | |
| 3G U2100 Macro Site | V | | |
| 3G U900 Macro Site | V | | |
| IBS (DAS) | | | |
| Low Profile & Gated Com (2G,3G) | | | |
| LTE | V | | |
| LTE Capacity Upgrade | | | |
| Transmission Upgrade | | | |
| Modernisation / Swap | | | |

| Site Drawings Approved | Antenna Changes have been updated in the MTN Antenna Database and |
|------------------------|---|
| | have been approved for installation |

| | | MTN SA Representative (Regional) (a, b, c, d, e only) | | |
|--------------|-----------------------------|---|--|--|
| Accept | Reject | Accept | Reject | |
| Name: H. Chi | lot | Name: M.C. | SoubERT | |
| Date: 20層 0 | \$ 21 | Date: 70(7) | 18-21 | |
| Signature: | thox | Signature: | | |
| | (Regional) (a, Accept Name: | Name: . Out # Date: 20 08 21 | (Regional) (a, b, c, d, e only) (Regional) (a, Accept Reject Accept Name: Name: MC Date: 207 Date: 207 | |



Part 10-2 Page 1 of 1.

GENERAL DRAWING LIST

- SITE LOCALITY MAP
- TYPICAL LOCATION PLAN
- AERIAL PHOTO
- SITE PLAN
- SITE PLAN
- BTS LAYOUT
- EARTHING LAYOUT
- APRON LAYOUT
- ELEVATION
- ELEVATION DETAIL
- EXCAVATE
- CONTAINER DETAIL
- PHOTOS
- FOUNDATION
- FOUNDATION
- FOUNDATION ROTATION

Mike Joubert

ZUSTERSTROOM

T-NUMBER: X100301

LAND ID:

WBS No:

17/07/17

RADIO ENGINEER:

MPUMALANGA OFF THE R544,

± 36.4km NORTH OF EMALAHLENI

Network Group - Northern Region Date: 1 7687 - 8-4

LATITUDE: 25"37"12.53"S

ONGITUDE

29" 02'32.24"E

RFQ No:

ROJECT No:



20/07/17

JAN MALAN DRAWN BY:

SITE SUPERVISOR

OUIS BOTHA







TOWCON

CAUTENC OFFICE:
730 LAKINER ROMO, BOM ACCURD, GAUTENC REPUBLIC OF SOUTH AFRICA
TEL: (+2712) 562 0454
FAX: (+2712) 562 0302 ower Construction

FREE STATE OFFICE:
78 STEWN STREET, HENNENMAN
REPUBLIC OF SOUTH AFRICA
TEL: (+2757) 573 2128
FAX: (+2786) 559 9571 EMAIL ADDRESS: TOWCONCIVILS@GMAIL.COM

ALL WORK PERFORMED ACCORDING
TO MTN BTS SITE INFRASTRUCTURE SPECIFICATION ISSUE
10 REVISION 1, SEPTEMBER 2014

| | | NO | | |
|--|--------------------|-------------|---------|---|
| | 25/07/17 | DATE | | |
| | ISSUED FOR PROPOSA | DESCRIPTION | MTM | 1 110000 |
| | OR PROP | NOI | K100301 | 1 1100 |
| | OSAL | | 0 | 110, 0111111111111111111111111111111111 |
| | | | × | 1 100 1 100 |

All rights, title and copyright in drawings, design, specification, manuals and technical information prepared for or provided to the supplier by Towcon Civils (Pty) Ltd, remains the property of Towcon Civils (Pty) Ltd, and are provided to the supplier in confidence. The supplier in confidence and shall not reproduce, divulge to others or use purposes other than in fulfillment of Towcon Civils (Pty) Ltd.

DIMENSIONS VERIFIED ON SITE BEFORE COMMENCEMENT OF ANY WORK DRAWINGS MUST NOT BE SCALED. ONLY FIGURED DIMENSIONS USED.

SHEET 0 OF 16

Scale: NTS

Drawing Reference:



也

ġı

via N4

Fastest route, the usual traffic



1269 Pretorius St Hatfield, Pretoria, 0028

Head west on Pretorius St/M2/N4 toward Duncan St/M7

ţ, onto Duncan St/M7 Use the left lane to turn left at the 1st cross street

Ĺ Use the left 2 lanes to turn left onto Francis Baard St/M2/N4 Continue to follow N4

A Partis toll road

7 Keep right to stay on N4

77 0 km

2 R104/Highveld/Wakefield/Kromdraai Take exit 86 toward

t Turn left

12.9 km

Turn left onto R544

Ċ

Destination will be on the right

R544

13.2 km



Z Ezenwek I B SITE Network Group - Northern Region Jigh. LOCATION Cell/ 083 2/12 9613 Mike Joubert 18-110 H N 10 1 h 18 mi 10 1 h 12 n

20/07/17

NIN

HUAWE

JAN MALAN DRAWN BY: 17/07/17

RADIO ENGINEER:

SITE SUPERVISOR

LOUIS BOTHA

± 36.4km NORTH OF EMALAHLENI MPUMALANGA

OFF THE R544,

SITE ADDRESS:

LATITUDE: 25"37"12.53"S

PROJECT No: RFQ No: OP/MONE/

LONGITUDE: 29" 02'32.24"E

LAND ID: T-NUMBER: X100301

WBS No:

ZUSTERSTROOM

TYPICAL LOCATION PLAN SHEET 1 OF 16 Scale: NTS Drawing Reference: 80

REV:

ALL WORK PERFORMED ACCORDING
TO MTN BTS SITE INFRASTRUCTURE SPECIFICATION ISSUE
10 REVISION 1, SEPTEMBER 2014 ROJECT

FREE STATE OFFICE:
78 STEVN STREET, HENNENMAN
REPUBLIC OF SOUTH AFRICA
IEL: (+2757) 573 2136
FAX: (+2786) 559 9571

EMAIL ADDRESS: TOWCONCIVILS@GMAIL.COM

GAUTENG OFFICE: 730 LAWNOER ROAD, BRY ACCORD, GAUTENG REPUBLIC OF SOUTH AFRICA TEL: (+2712) 562 0362 FAX: (+2712) 562 0302

Tower Construction CIVILS (Pty) Ltd

JWCON

T No: SHEET No: REVISIO

25/07/13 DESCRIPTION ISSUED FOR PROPOSAL

DIMENSIONS VERIFIED ON SITE BEFORE COMMENCEMENT OF ANY WORK. DRAWINGS MUST NOT BE SCALED. ONLY FIGURED DIMENSIONS USED. supplier in confidence. The supplier shall hold such

All rights, title and copyright in drawings, design, specification, manuals and technical information prepared for or provided to the supplier by Towcon Civils (Pty) Ltd., remains the property of Towcon Civils (Pty) Ltd. and ore provided to the sign in confidence and shall not reproduce, divulge to others or use purposes other than in fulfillment of Towcon Civils (Pty) Ltd.

All rights, little and copyright in drawings, design, specification, manuals and technical information prepared for or provided to the supplier by Towcon Civils (Pty) Ltd, remains the property of Towcon Civils (Pty) Ltd, and are provided to the information and design in confidence and shall not reproduce, divulge to others or use purposes other than in fulfillment of Towcon Civils (Pty) Ltd. SITE ORIENTATION OFFSET 17' MN Network Group - Northern Region Date: 12017-8-21 Sign: DIMENSIONS VERIFIED ON SITE BEFORE COMMENCEMENT OF ANY WORK. DRAWINGS MUST NOT BE SCALED. ONLY FIGURED DIMENSIONS USED. Cell: 083,212 9613 Mike Joubert MTN SITE LOCATION SHEET 2 OF 16 supplier in confidence. The supplier shall hold such Scalet NTS TIS SEA REV: Drawing Reference: 80 No FREE STATE OFFICE 78 STE'N STREET, HENNENMAN REPUBLIC OF SOUTH AFRICA TEL: (+2757) 573 2128 FAX: (+2786) 559 9571 CAUTENG OFFICE:
730 LAKENGER ROAD, BON ACCORD, CAUTENG REPUBLIC OF SOUTH AFRICA
TEL: (+2712) 562 0454
FAX: (+2712) 562 0302 ISSUED FOR PROPOSAL JAN MALAN ZUSTERSTROOM PROJECT T No: SHEET No: REVISION MTN \$100301 2 A ALL WORK PERFORMED ACCORDING
TO MIN BIS SITE INFRASTRUCTURE SPECIFICATION ISSUE
10 REVISION 1, SEPTEMBER 2014 17/07/17 LAND ID: T-NUMBER: X100301 OFF THE R544, ± 36.4km NORTH OF EMALAHLENI EMAIL ADDRESS: TOWCONCIVILS@GMAIL.COM 20/07/17 SITE SUPERVISOR: RADIO ENGINEER: MPUMALANGA LONGITUDE: 29" 02'32.24"E LATITUDE: 25°37'12.53"S PROJECT No: RFQ No: OP /MONE/ LOUIS BOTHA SITE ADDRESS: NIM Tower Construction CIVILS (Pty) Ltd OWCON HUAWEI

All rights, title and copyright in drawings, design, specification, manuals and technical information prepared for or provided to the supplier by Towcon Civils (Pty) Ltd, remains the property of Towcon Civils (Pty) Ltd, and are provided to the supplier in confidence. The supplier in confidence and shall not reproduce, divulge to others or use purposes other than in fulfillment of Towcon Civils (Pty) Ltd. SITE ORIENTATION OFFSET 17' MN Site position MTN SITE LOCATION DIMENSIONS VERIFIED ON SITE BEFORE COMMENCEMENT OF ANY WORK. DRAWINGS MUST NOT BE SCALED. ONLY FIGURED DIMENSIONS USED. SHEET 3 OF 16 REV. Scale: NTS AERIAL PHOTO R544 ENTRANCE 80 FREE STATE OFFICE:
78 STEWN STREET, HENNENMAN
REPUBLIC OF SOUTH AFRICA
TEL: (+2757) 573 2128
FAX: (+2786) 559 9571 ISSUED FOR PROPOSAL SURVEY DATE: 17/07/17 ALL WORK PERFORMED ACCORDING
TO MTN BTS SITE INFRASTRUCTURE SPECIFICATION ISSUE
10 REVISION 1 , SEPTEMBER 2014 JAN MALAN PROJECT T No: SHEET No: REVISIO GAUTENG OFFICE: 730 LANDIER ROAD, BON ACCORD, GAUTENG REPUBLIC OF SOUTH AFRICA TEL: (+2712) 562 0454 FAX: (+2712) 562 0302 TOWCON RFQ No: OP/MONE/ EMAIL ADDRESS: TOWCONCIVILS@GMAIL.COM 20/07/17 LOUIS BOTHA SITE SUPERVISOR: RADIO ENGINEER: MPUMALANGA OFF THE R544, ± 36.4km NORTH OF EMALAHLENI LONGITUDE: 29" 02'32.24"E LATITUDE: 25.37,12.53,8 PROJECT No: LAND ID: SITE ADDRESS: MIN


HUAWE


ZUSTERSTROOM


T-NUMBER: X100301


rights, title and capyright in drawings, design, specification, manuals and technical information prepared for or provided to the supplier by Towcon Civils (Pty) Ltd, remains the property of Towcon Civils (Pty) Ltd, and ore provided to the supplier in confidence. The supplier shall have a confidence and shall not reproduce, divulge to others or use purposes other than in fulfillment of Towcon Civils (Pty) Ltd. SITE ORIENTATION OFFSET 17' MN 2/448 MTN SITE LOCATION NOTES:


SITE ACCESS:
1.SAQ TO ARRANGE ACCESS WITH LAND AFFAIRS.
1.SAQ TO ARRANGE ACCESS WITH ACCESS W FARM HOUSE PROPERTY GRAVEL ROAD TO SITE Network Group - Northern Region Cell: 083 712 9613 Date: TRL 1-8-1 DIMENSIONS VERIFIED ON SITE BEFORE COMMENCEMENT OF ANY WORK. DRAWINGS MUST NOT BE SCALED. ONLY FIGURED DIMENSIONS USED. Mike Joubert TURN OFF LAT: 25'39'Z2.75'S -LONG: 29' 6'54.62'E SHEET 4 OF 16 Scale: NTS TAR ROAD (R544) SITE PLAN REV: Drawing Reference: 80 ±31km 10 R25 #31km 10 EMALAHLENI 25/07/17 FREE STATE OFFICE 78 STEYN STREET, HENNENMAN REPUBLIC OF SOUTH AFRICA TEL. (+2757) 573 2128 FAX. (+2786) 559 9571 ISSUED FOR PROPOSAL ALL WORK PERFORMED ACCORDING
TO MTN BTS SITE INFRASTRUCTURE SPECIFICATION ISSUE
10 REVISION 1 , SEPTEMBER 2014 ZUSTERSTROOM SURVEY DATE: 17/07/17 X100301 PROJECT T No: SHEET No: REVISIO RFQ No: EMAIL ADDRESS: TOWCONCINLS@GMAIL.COM GAUTENG OFFICE: 730 LANDAYER ROAD, BON ACCORD, GAUTENG REPUBLIC OF SCUTH AFRICA TELL (+2712) 562 0454 FAX: (+2712) 562 0302 20/07/17 JAN MALAN DRAWN BY: SITE SUPERVISOR: RADIO ENGINEER: MPUMALANGA OFF THE R544, ± 36.4km NORTH OF EMALAHLENI LONGITUDE: 29" 02'32.24"E LATITUDE: 25.37,12.53,8 PROJECT No: WBS No: LAND ID: LOUIS BOTHA SITE ADDRESS OP/MONE/ T-NUMBER: Tower Construction CIVILS (Pty) Ltd NIN OWCON HUAWEI

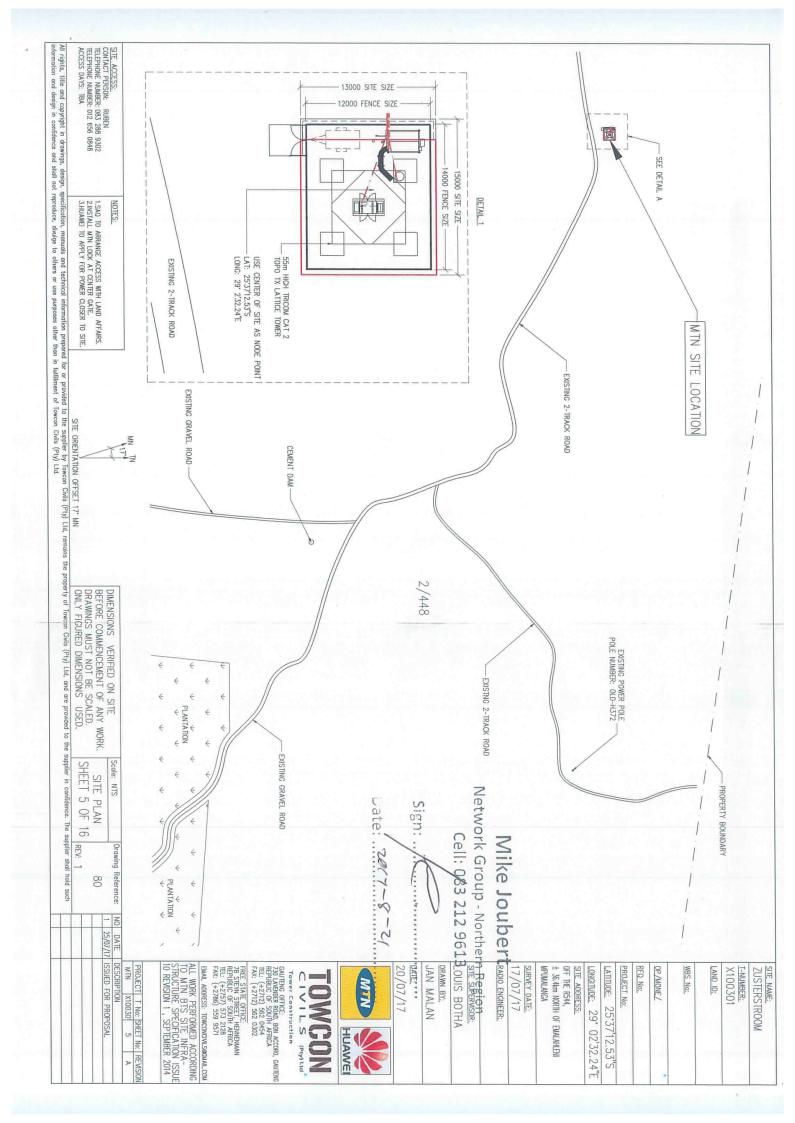


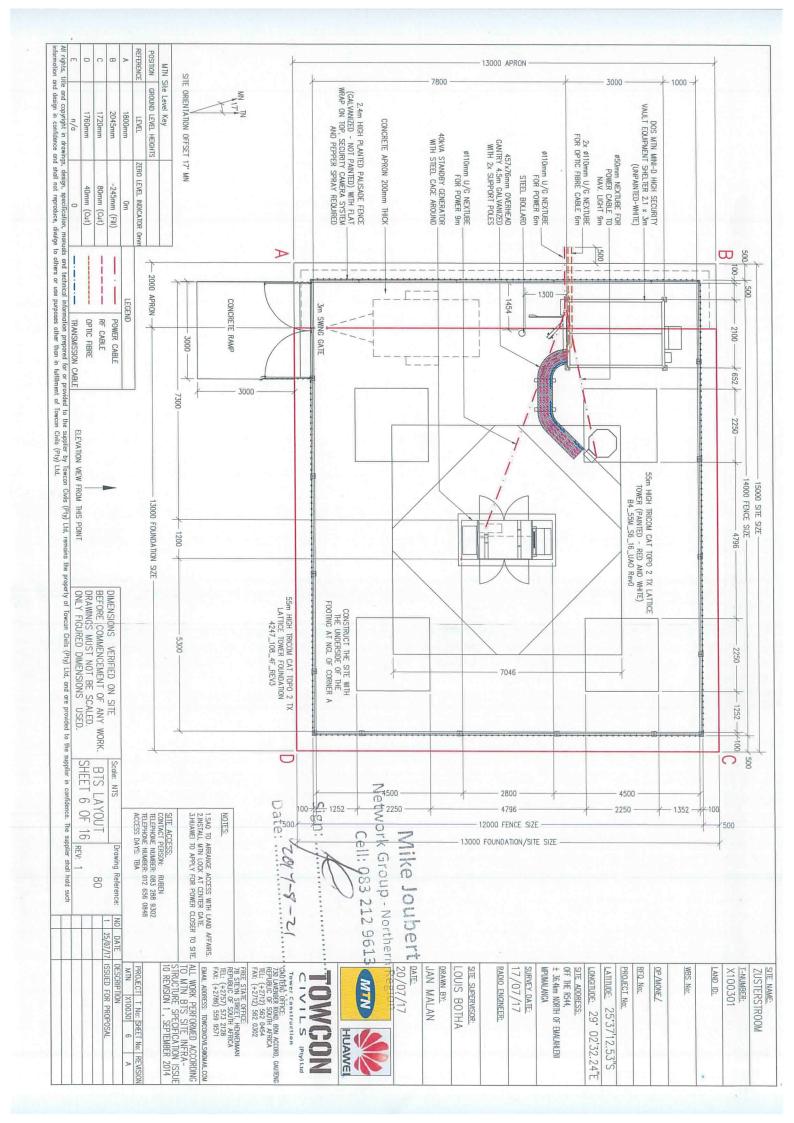


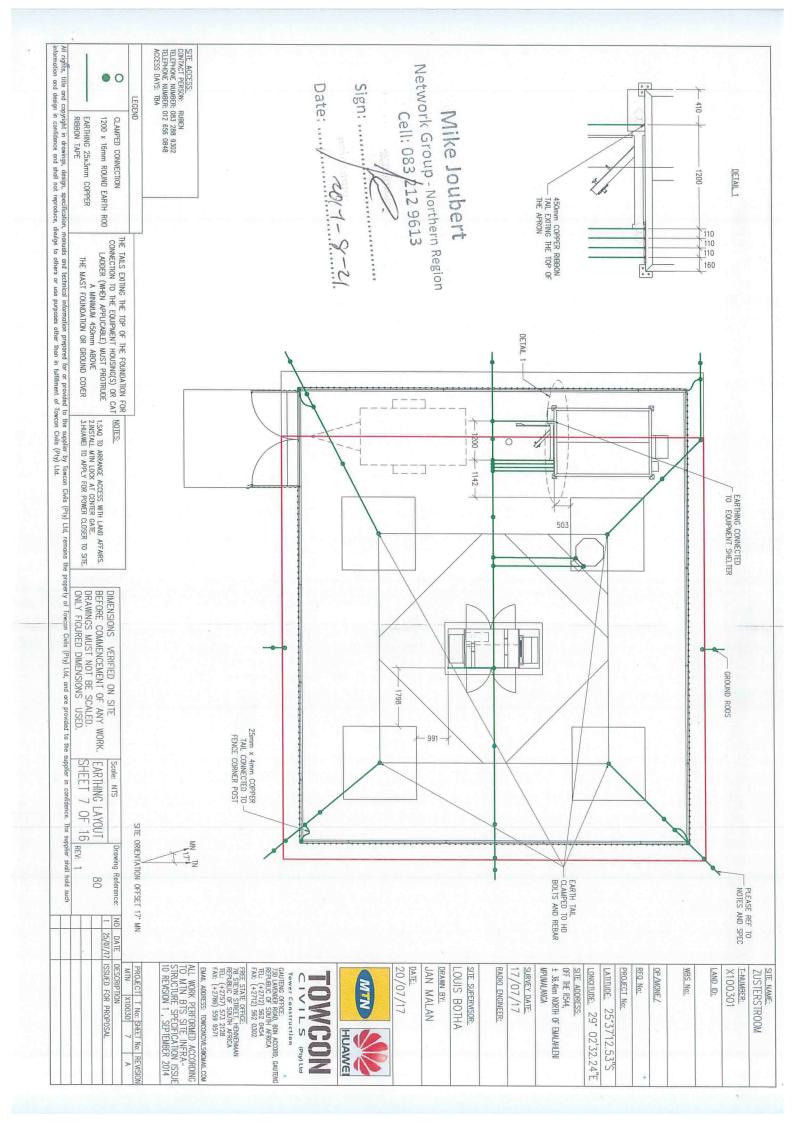


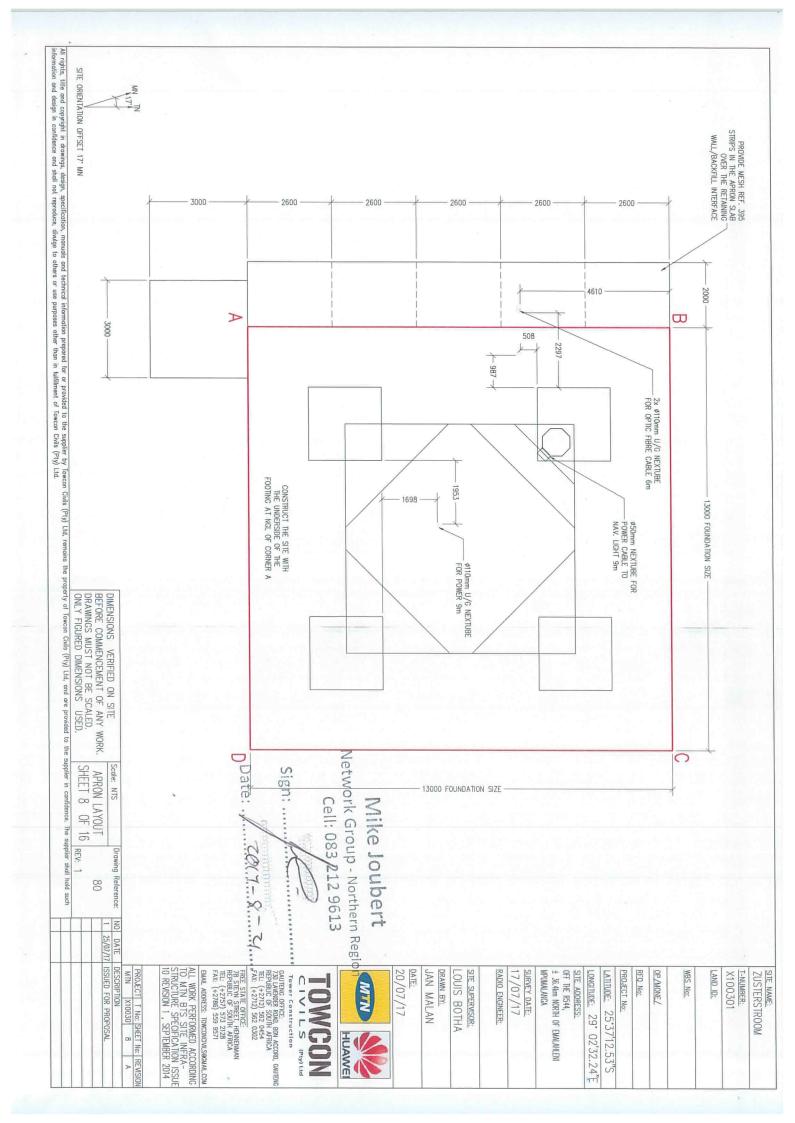

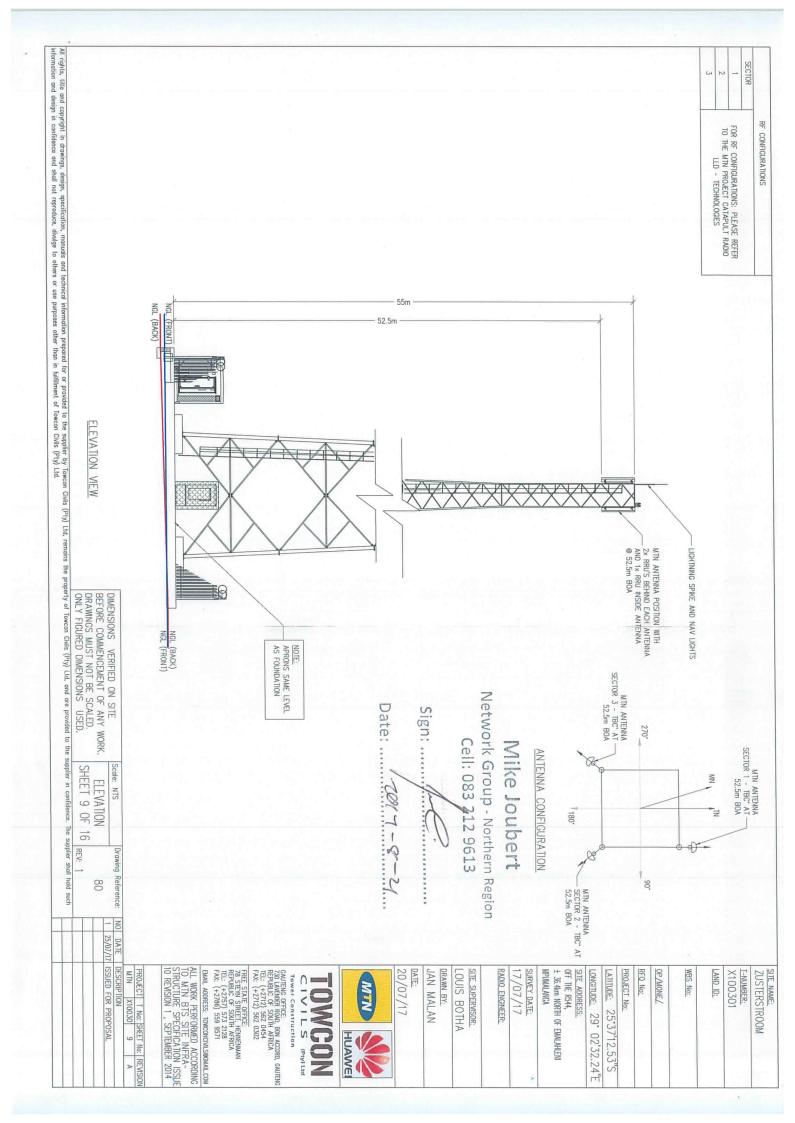


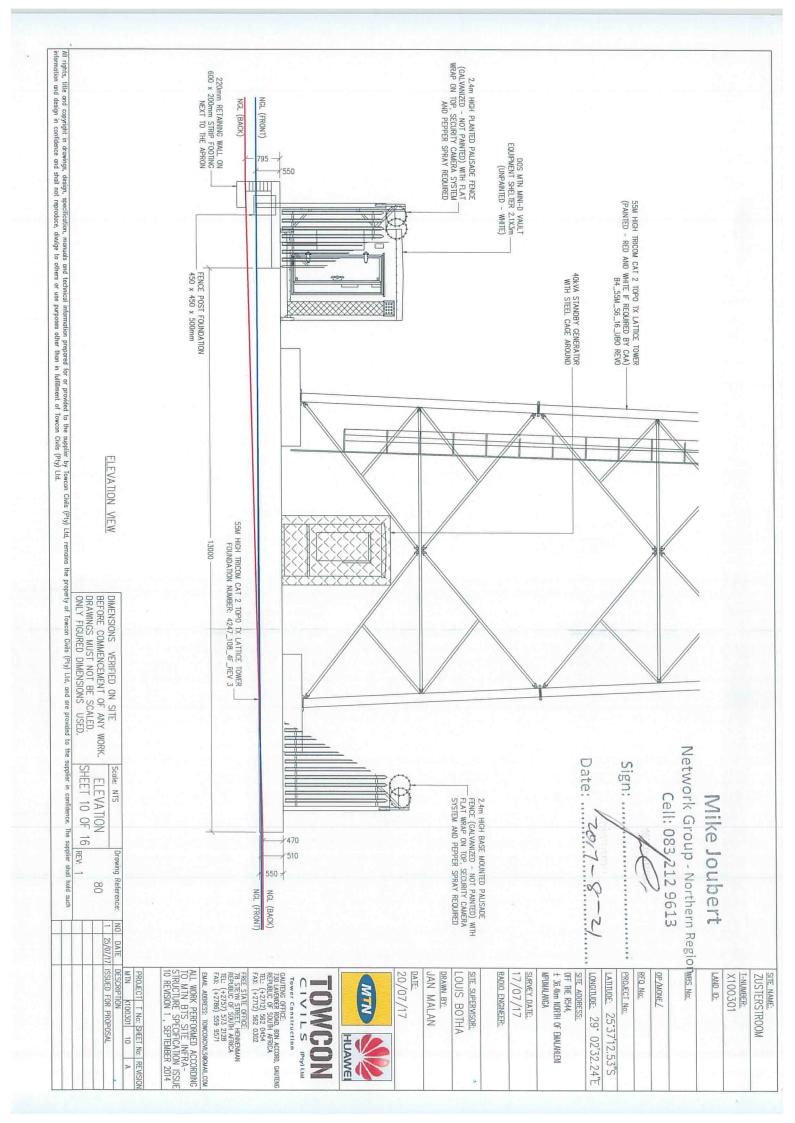


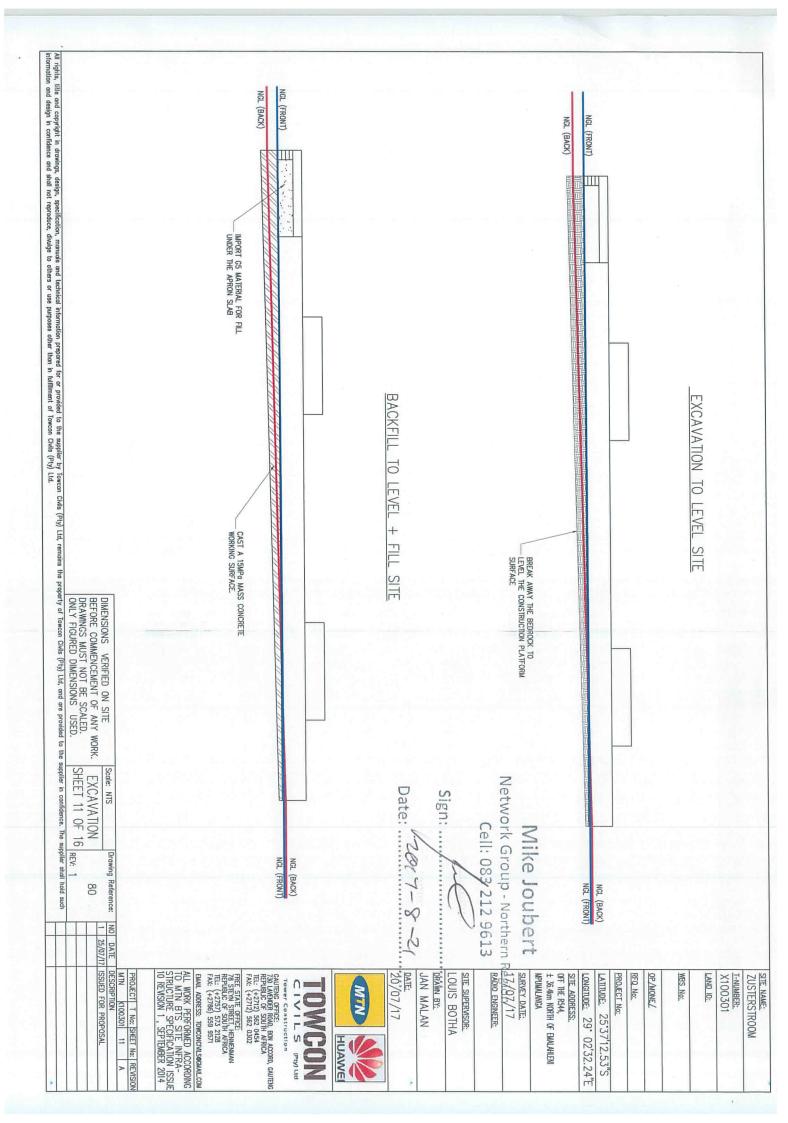

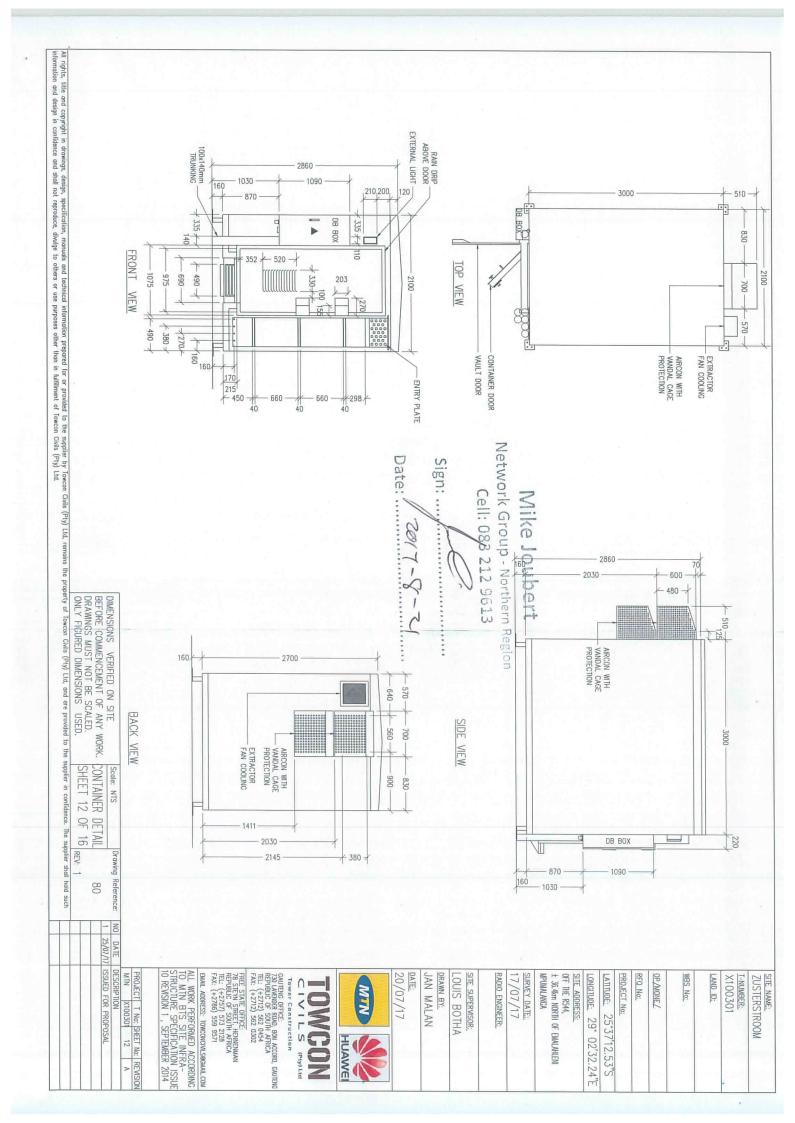

All rights, title and copyright in drawings, design, specification, manuals and lectmical information prepared for or provided to the supplier by Towcon Civils (Pty) Ltd, remains the property of Towcon Civils (Pty) Ltd, and are provided to the supplier in confidence. The supplier shall had such information and design in confidence and shall not reproduce, divulge to others or use purposes other than in fulfillment of Towcon Civils (Pty) Ltd. DIMENSIÓNS VERIFIED ON SITE BEFORE COMMENCEMENT OF ANY WORK, DRAWINGS MUST NOT BE SCALED. ONLY FIGURED DIMENSIONS USED. Network Group - Northern Region Date: . Sign: Cell: 083/212 9613 PHOTOS SHEET 13 OF 16 REV: 1 Scale: NTS Joubert Drawing Reference: 80 CAUTENG OFFICE:
730 LARRIGER ROAD, BON ACCORD, GAUTENG
REPUBLIC OF SOUTH AFRICA
TEL: (+2712) 562 0454
FAX: (+2712) 562 0302 FREE STATE OFFICE:
78 STEWN STREET, HENNENMAN
REPUBLIC OF SOUTH AFRICA
TEL: (+2757) 573 2128
FAX: (+2786) 559 9571 ISSUED FOR PROPOSAL ALL WORK PERFORMED ACCORDING
TO MTN BTS SITE INFRASTRUCTURE SPECIFICATION ISSUE
10 REVISION 1, SEPTEMBER 2014 PROJECT T No: SHEET No: REVISION MTN X10030 13 A TOWCON SURVEY DATE: 17/07/17 T-NUMBER: X100301 ZUSTERSTROOM EMAIL ADDRESS: TOWCONCIVILS@GMAIL.COM 20/07/17 JAN MALAN DRAWN BY: RADIO ENGINEER: OFF THE R544, LAND ID: SITE SUPERVISOR: MPUMALANGA ± 36.4km NORTH OF EMALAHLENI LONGITUDE: 29" 02'32.24"E LATITUDE: 25°37'12.53"S _OUIS BOTHA PROJECT No: RFQ No: OP /MONE / NIN HUAWEI

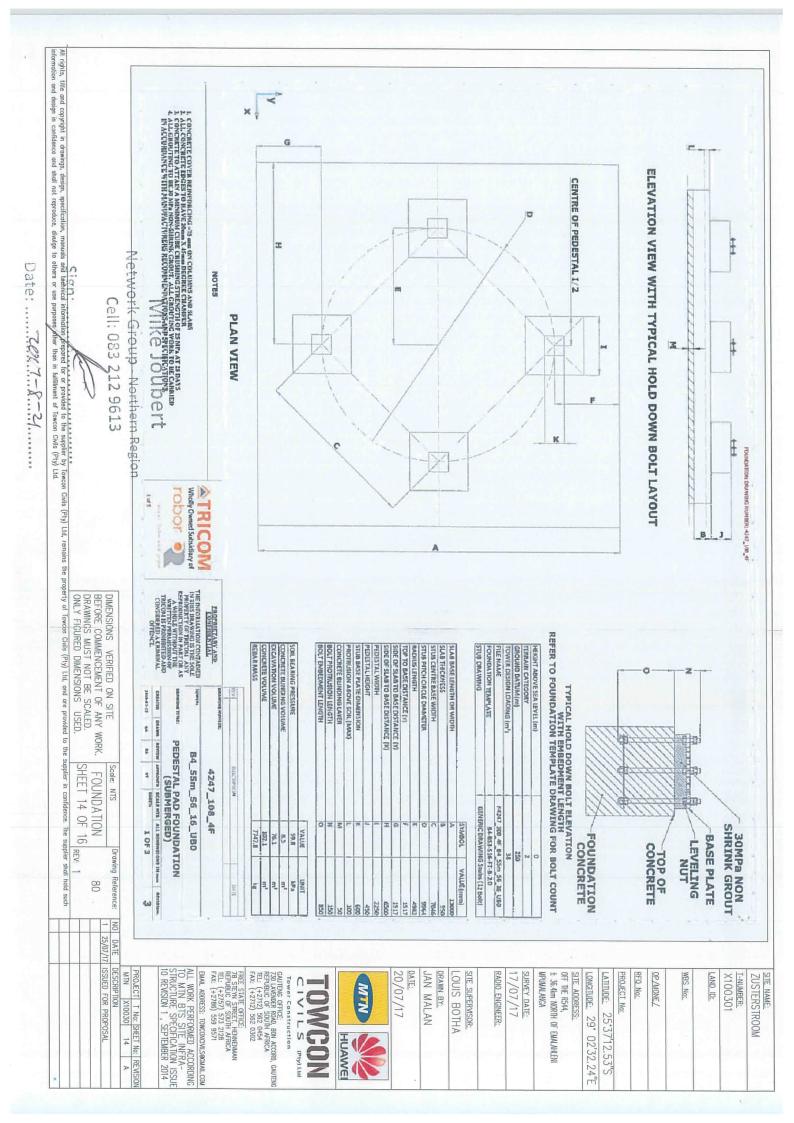

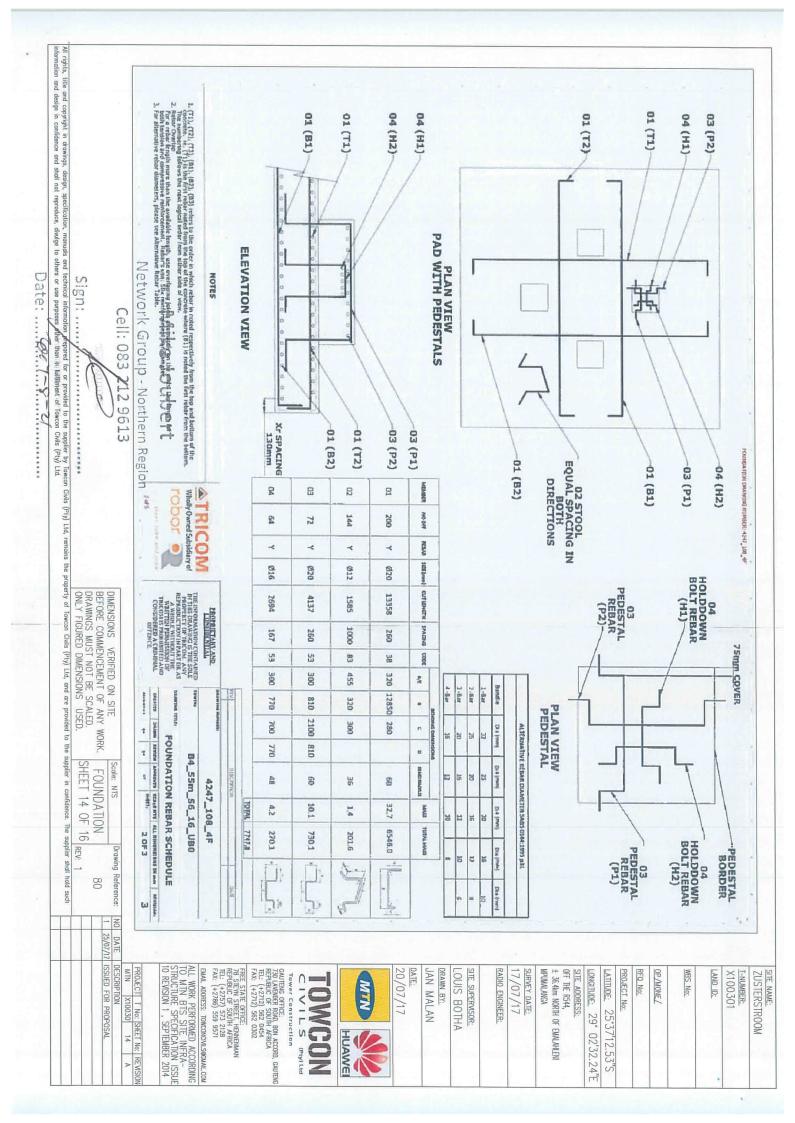

Sent: Thursday, 04 May 2017 4:48 PM From: David Perry [MTN South Africa] [mailto:David.Perry@mtn.com]

To: jimmykempsa@gmail.com; towconcivils@gmail.com

Cc: David Perry [MTN South Africa]

Subject: FW: Tower rotationon on foundation

Please see the confirmation that the tower may be rotated as discussed.

Many thanks Remember that you must obtain the In-Situ capacity certificate as well, which must reference this change and confirm the capacity in this location. This mail must form part of you build documentation pack and issued to the Pr Engineer for the Completion Build certificate.

Kind Regards,

David Perry

Senior Specialist: Product Specifications and Quality


David.Perry@mtn.com

To: David Perry [MTN South Africa] < David.Perry@mtn.com> Sent: Thursday, 04 May 2017 2:48 PM From: Theo Venter [mailto:Tventer@tricom1.co.za]

Helio Sir

Subject: Tower rotationon on foundation Cc: Udo Topka < Utopka@tricom1.co.za>

We agree that the pedestal(s) on the slab may be rotated 45 degrees to sit parallel (square) to the slab sides and in the corner(s) of the slab

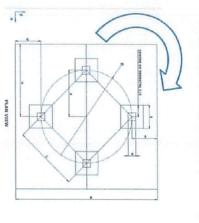



Mike Joubert

Network Group - Northern Region Cell: 083 212 9613

Sign:





JAN MALAN



20/07/17



CIVILS (Phy)Ltd. OWCON

CAUTENG OFFICE:
730 LAKRUSER ROAD, BON ACCORD, CAUTENG REPUBLIC OF SOUTH AFRICA
TEL: (+2712) 562 0454
FAX: (+2712) 562 0302 Tower Construction

FREE STATE OFFICE:
78 STEYN STREET, HENNENMAN
REPUBLIC OF SOUTH AFRICA
TEL: (+2757) 573 2128
FAX: (+2786) 559 9571

EMAIL ADDRESS: TOWCONCIVILS@CMAIL.COM

ALL WORK PERFORMED ACCORDING
TO MTN BTS SITE INFRASTRUCTURE SPECIFICATION ISSUE
10 REVISION 1, SEPTEMBER 2014 NZ MTN X10030 14 A X10030

Drawing Reference: 80 ISSUED FOR PROPOSAL

All rights, title and copyright in drawings, design, specification, manuals and technical information prepared for or provided to the supplier by Towcon Civils (Pty) Ltd, remains the property of Towcon Civils (Pty) Ltd, and are provided to the supplier in cartidence. The supplier shall had such intermation and design in confidence and shall not reproduce, divulge to others or use purposes other than in fulfillment of Towcon Civils (Pty) Ltd. DIMENSIONS VERIFIED ON SITE BEFORE COMMENCEMENT OF ANY WORK. DRAWINGS MUST NOT BE SCALED. ONLY FIGURED DIMENSIONS USED. SHEET 14 OF 16 REV. Scale: NTS FOUNDATION

George Small Consult c.c

Reg. No: CK98/57340/23

P.O.Box 1236 Muldersdrift 1747

Tel: 083 397 9577 Fax: 086 621 0124 (george.small@3gi.co.za)

E 29.042289

17 July 2017

ENGINEER'S REPORT - GREENFIELD INSTALLATIONS - Revision 1

Site ID:

X 100301

Site Name:

ZUSTERSTROOM

Site Co-ordinates:

S 25.620194

Height above sea level:

1536

Artificial ground datum:

200+

Terrain category

B

Introduction

We have surveyed the proposed position of the site on 17 July 2017.

The site is considered suitable for the proposed installation according to requirements of the MTN SA T1/01/1001 specification (Issue 10, Revision 1, dated September 2014)

Mast description

55m Cat2 Topo TRSM 'Tricom' lattice mast

Footing drawing number: 4247 108 4F Rev 3

(or latest audit number)

Tower drawing number: β4 55m S6 16 UBO Rev 0 (or latest audit number)

Site levels and storm water drainage

North-west (B) = 2045

North-east (C) = 1720

South-west (A) = 1800

South-east (D) = 1760

Construct the site with the underside of the footing at the NGL of the south-western corner of the site.

Construct 220 retaining walls on the mass concrete working surface cast on the cleared bedrock under the apron slab. Provide mesh ref. 395 strips in the apron slab over the retaining wall/backfill interface. 19

Bearing capacity and soil type.

Visual observation revealed conglomerate sediment bedrock with a 300KPa+ bearing capacity.

Network Group - Northern Region Cell: 083 212/9613

Proposed earthworks

Break away the bedrock to level the construction platform surface and cast a 15MPa mass concrete working surface.

Cast an above ground footing and import G5 material for fill under the apron slab.

Estimated earthworks quantities

Earthworks must comply with the relevant items of SANS 1200 DA and the MTN specification.

Excavated and cleared areas must be ripped, scarified, wetted to optimum moisture content (OMC) and compacted to 93% MOD AASHTO density with 'whackers' prior to placement of fill or casting of concrete.

Fill material at OMC must be placed in layers and compacted with 'whackers' to 93% MOD AASHTO density such that the compacted layer thickness does not exceed 150mm. No bulking factors (top soil = 1.35, imported fill = 1.25) have been included in the quantities below.

Break away bedrock and spoil Cast 15MPa concrete working surface Imported G5 fill

6m3

12m3

9m3

Natural and artificial obstacles Nil.

GP. SMALL (Pr. Eng. 820484)

Network Group - Northern Region