
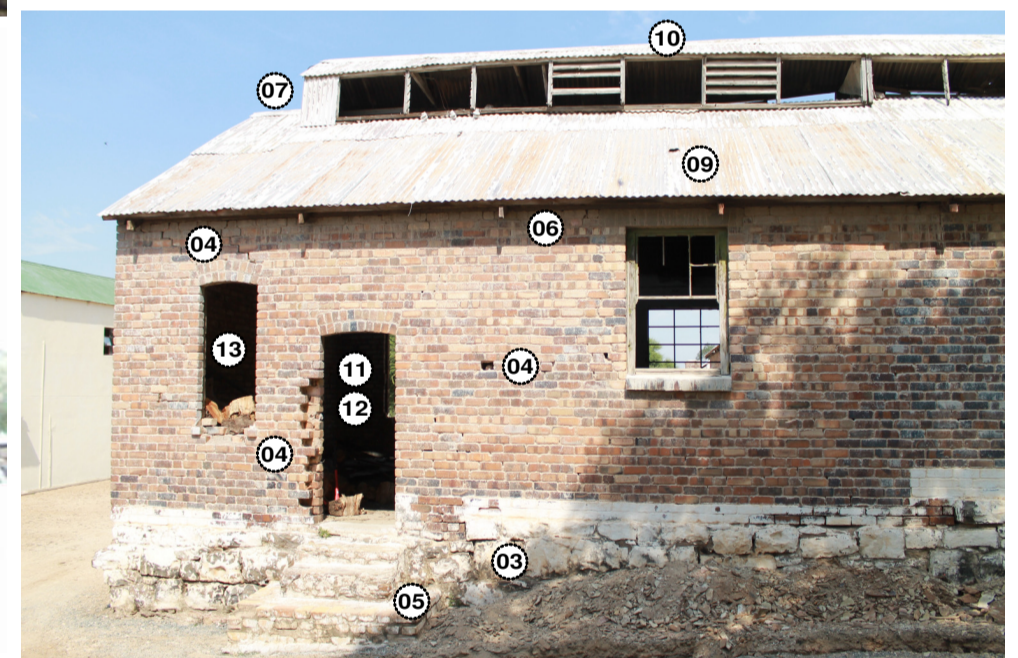
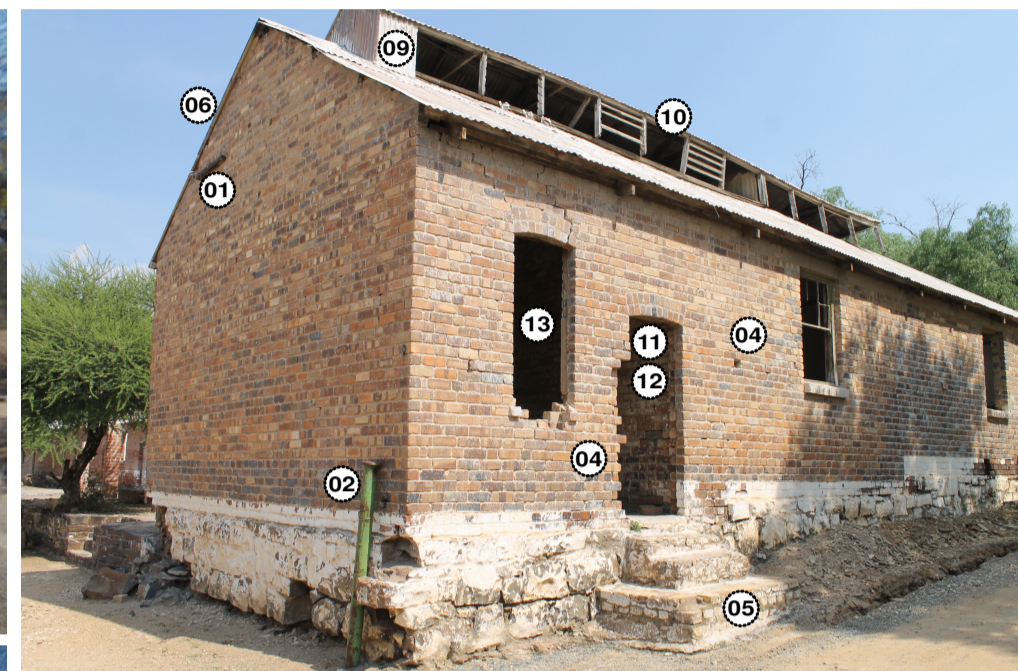
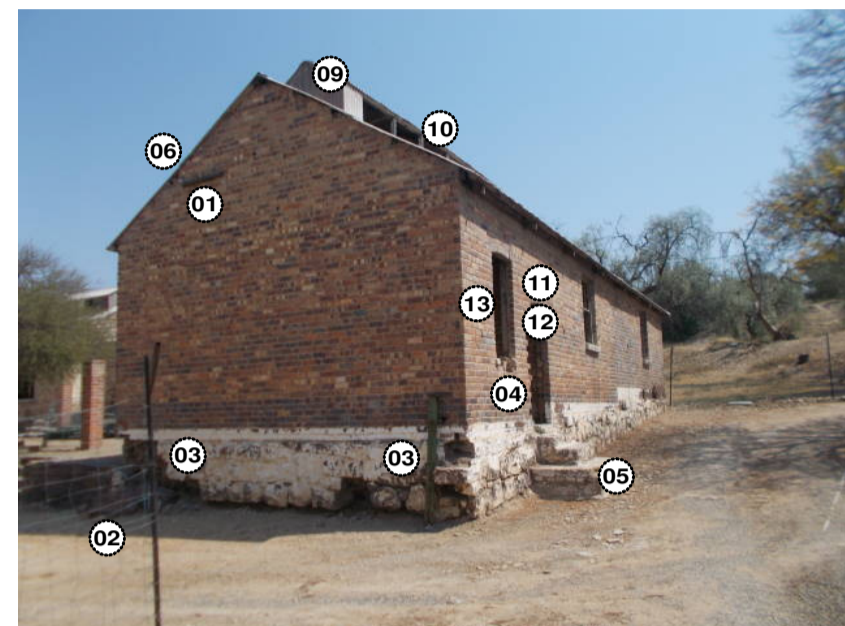


ground floor plan
scale 1:100

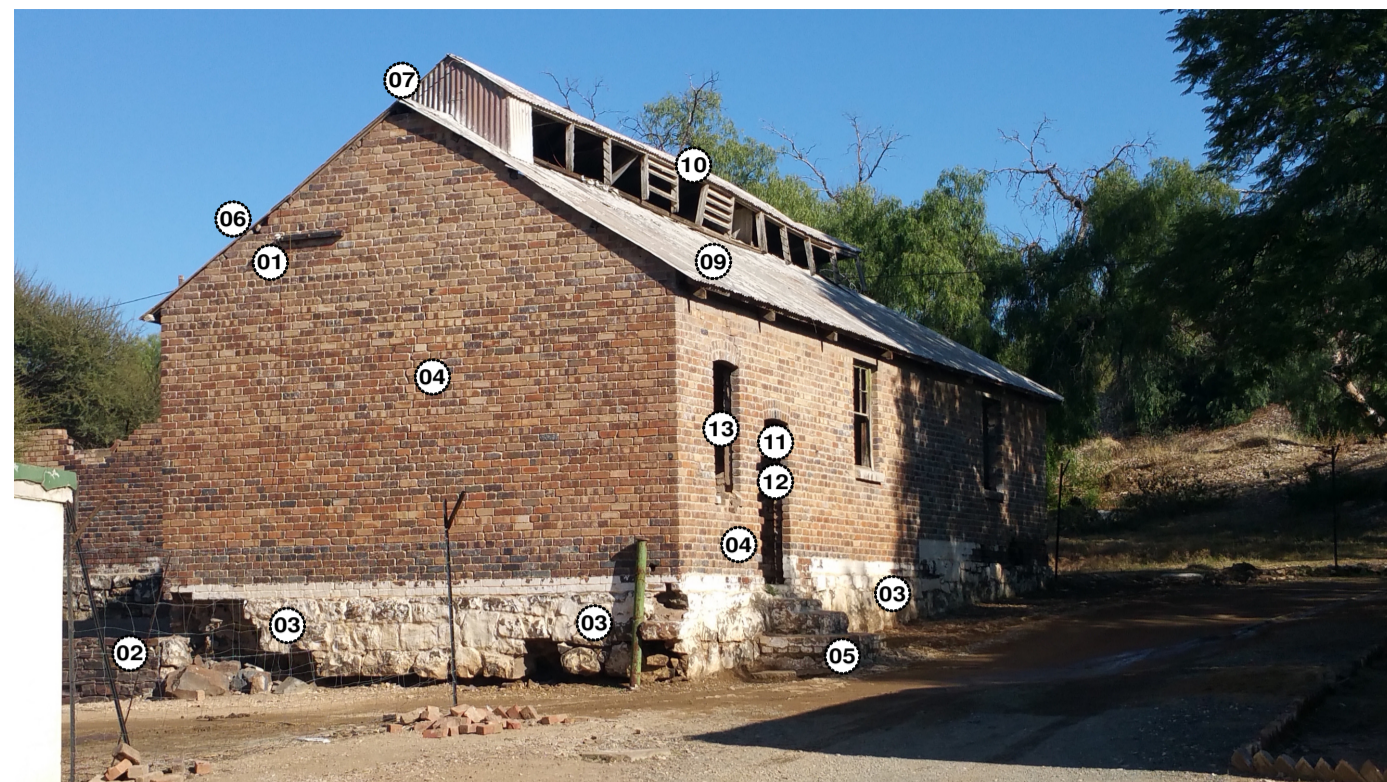

- 01 remove cables and steel members from walls
- 02 remove wire fence and poles
- 03 existing rock foundation to be inspected and repaired to its original state, rebuild foundations as per engineers specifications. clean all paint from rock.
- 04 make good brickwork, replace damaged and broken bricks to match existing. fill facebrick joints properly. clean all excess paint and concrete off bricks. cracks to be inspected and repaired as per structural engineers detail. ensure that new finishes match existing.
- 05 make good rock step below door. to be inspected and repaired to its original state. clean all paint from rock.
- 06 make good beam filling
- 07 check flashing and ensure that no roof leaks are present, seal properly. replace flashing if necessary
- 08 inspect all roof truss members, replace where necessary. clean wood properly. seal exterior members with Woodoc 30 low gloss, clear, polywax sealer and internal members with Woodoc 5 matt, clear polywax sealer.
- 09 inspect roof sheeting, check for rust, holes and leaks on joints. repair where possible and replace if necessary. sand down all flaking paint. clean roof sheeting and paint as per specification.
- 10 inspect roof sheeting, check for rust, holes and leaks on joints. repair where possible and replace if necessary. sand down all flaking paint. clean roof sheeting and paint as per specification. inspect wooden members, replace if necessary. sand down and seal wooden members with Woodoc 30 low gloss, clear, polywax sealer. fill openings between louvres with purpose made windows as per window schedule. replace broken wooden louvres to match original, and treat as per roof members. stainless steel mesh to be installed behind all louvres.
- 11 measure door openings, replace door frames with solid wooden frames to match compound western block frames, seal with Woodoc 30 low gloss polywax sealer.
- 12 supply and install new solid hardwood door as per door schedule. sand down and clean. seal with Woodoc 30 low gloss, clear poly wax sealer. All ironmongery to be brass, door lock and handle to architects approved sample.
- 13 supply and install new window as per window schedule, sand down and clean wooden frame, seal with Woodoc 30 low gloss, clear, polywax sealer.
- 14 replace broken roof trusses with new oregon pine trusses to match existing trusses. clean wood and seal with Woodoc 30 low gloss, clear poly wax sealer.
- 15 existing floor surface bed to be inspected, repair to its original state as per engineers specifications.
- 16 strip out all electrical.

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No.	Date	Notes	Drawn
Rev 00	20-04-17	Revised for measurement	NGM
Rev 00	09-06-17	Construction drawings	NGM

GENERAL NOTES:

1. Check all measurements, levels and details on site before commencement with work.
2. Refer any discrepancies to architect
3. All work to be done in accordance with SANS-10400
4. Nothing to be scaled from drawing; request measurement from architect
5. Architect's & engineer's drawings to be read together
6. Drawing to be used for intention as mentioned in Drawing description.



CLIENTS SIGNATURE:



DEPARTMENT'S SIGNATURE:



PRINCIPAL AGENT SIGNATURE:



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Rooi Na Business Park,
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ARCHITECTS SIGNATURE:

TITLE:

**PROPOSED ALTERATIONS
& ADDITIONS TO TAUNG SKULL
HERITAGE SITE
FOR NORTH-WEST RURAL,
ENVIRONMENTAL &
AGRICULTURE DEPARTMENT
PROVINCE OF NORTH-WEST**

DRAWING DESCRIPTION:
MINERS ROOM 16
REFURBISHMENT

ORIGINAL	A1
DRG. SIZE	
SCALE: 1/100	
REV.	0

DRG No.: TAUNG - 42017 - ARC - COR006

miners room 16
scale as shown