
FIRE PLAN

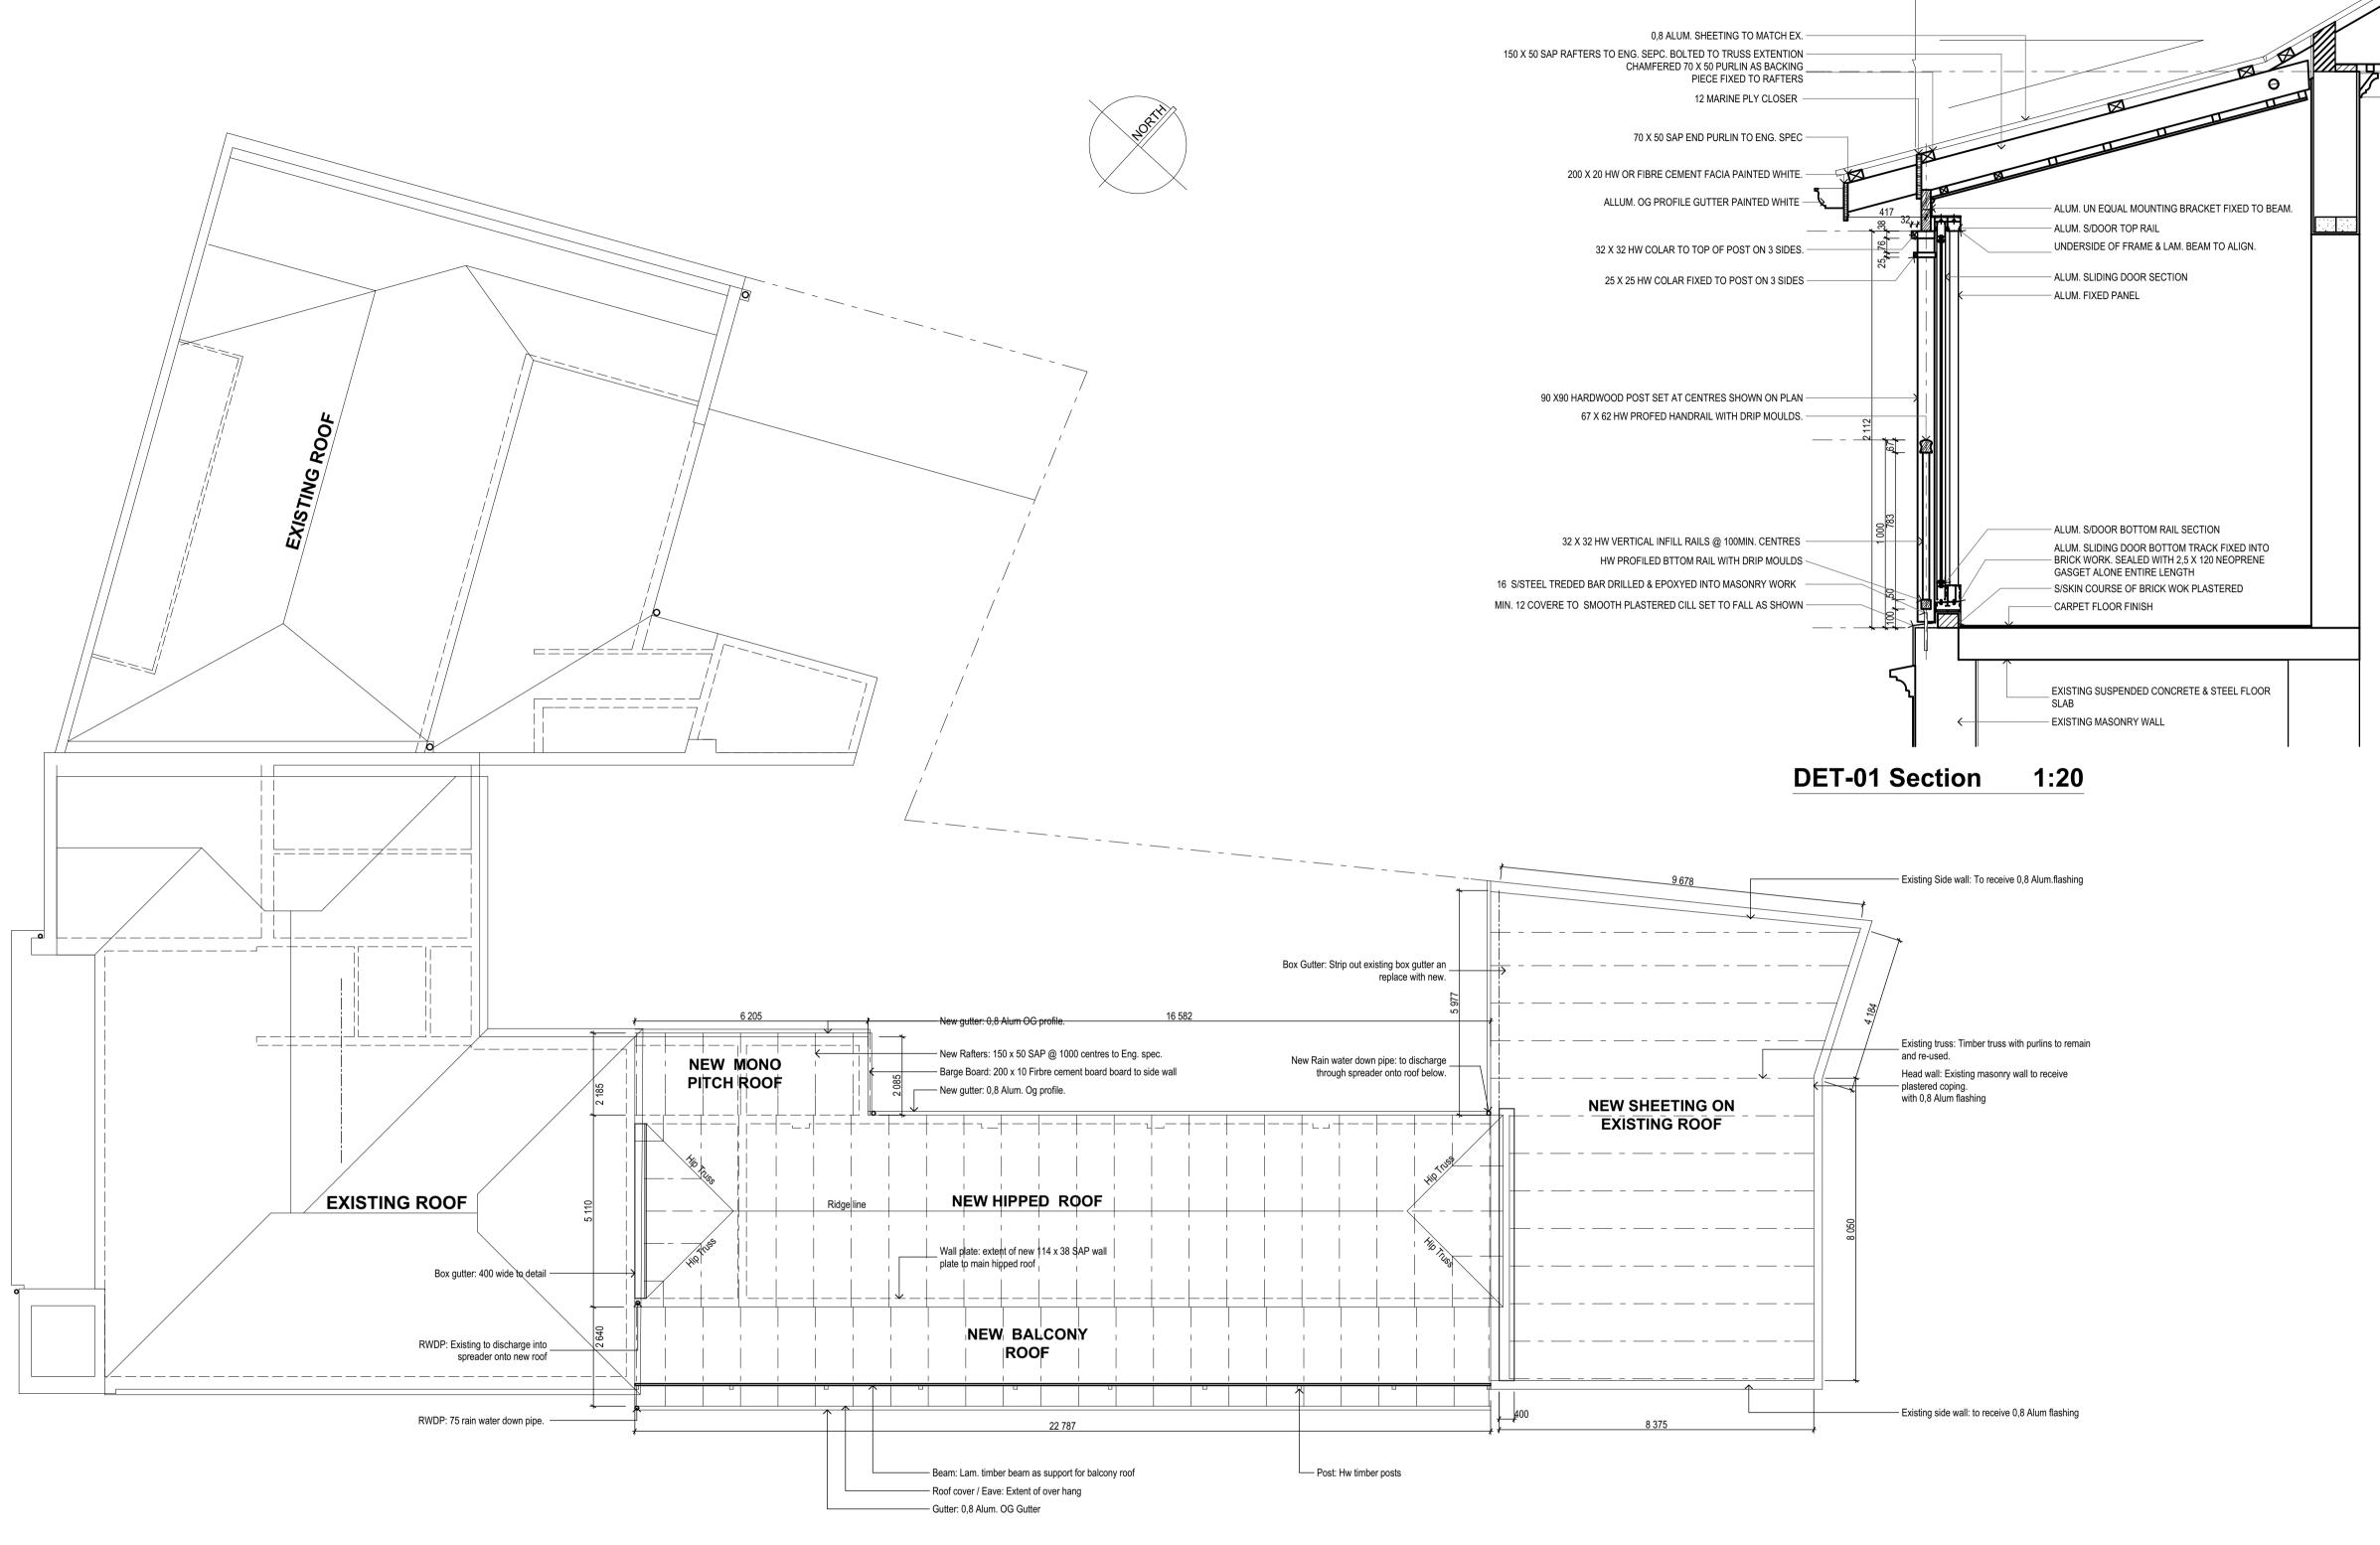

Roof Plan 1:100

GENERAL CONSTRUCTION:
ALL CONSTRUCTION WORK IS TO IN COMPLIANCE WITH: A] THE CODE OF PRACTICE AS SET OUT IN THE NATIONAL BUILDING REGULATIONS S.A.B.S 0400. B) LOCAL AUTHORITY BYLAWS C] STRICT ACCORDANCE WITH APPROVED PLANS AND SPECIFICATIONS. DI CONDITIONS INCLUDED IN REGISTERED TITLE DEED

STRUCTURAL STOTLIN

STRUCTURAL BUILDING SYSTEM TO BE IN ACCORD. WITH SABS 0400 PART B

ALL SUSPENDED SLABS, SURFACE BEDS, STAIRCASES, FOUNDATIONS, FOUNDATION WALLS AND

CONCRETE COLUMNS ALL TO STRUCTURAL ENGINEERS SPECIFICATIONS. TO BE SUBMITTED TO LOCAL AUTHORITY PRIOR COMMENCEMENT

FOUNDATION CONSTRUCTION:

WALL FOUNDATIONS ALL TO BE STRIP AND STEPPED AS REQUIRED TO MIN DIM. OF 600X200 IN ACCORDANCE WITH FLOOR CONSTRUCTION:

ALL FLOORS TO COMPLY WITH PART 'J' OF SABS 0400/1900. 100 CONC. SURFACE BED SLAB WITH REF.100 MESH. TO HAVE MIN.35 SCREED TO ACCEPT Q. TILE FINISH. UNDERSIDE TO BE CAST ON 250 MICRON DPM. ON CUT. SOIL POISONED TO SABS 0127

WALL CONSTRUCTION:

EXTERNAL MASONRY WALLS: 252 DOUBLE SKIN 110 CLAY BRICKS, OUTER FACE INTERNAL SKIN TO BE BAGGED & SEALED WITH BITUSEAL. BRICK FORCE TO BE USED EVERY 4TH COURSE & EVERY 2ND COURSE ABOVE ALL OPENINGS. 15mm SMOOTH PLASTERED & PAINT TO BOTH SIDES

INTERNAL MASONRY WALLS: 140 SINGLE SKIN 110 CLAY BRICKS, BRICK FORCE TO EVERY 4TH COURSE & EVERT 2ND COURSE OVER ALL OPENINGS. 15MM SMOOTH PLASTER & PAINT TO BOTH SIDES. ROOF CONSTRUCTION: REFER TO NOTES ON SECTION C-C

EXISTING SOFFIT TO BE RE-PLASTERED AND PAINTED **CEILING:**

9.5 RHINO BOARD GYPSUM PLASTER BOARD SCREW FIXED TO 38X38 BRANDING @ 300 CENTERS. JOINTS TO BE TAPED AND ENTIRE SURFACE TO BE SKIM PLASTERED WITH MIM. 3MM RHINOGLIDE. PAINTED.

SANITARY & STORM WATER DISPOSAL:

ALL DRAINAGE TO BE IN ACCORD. WITH SABS 0440 PART P ALL SEWER DRAINS TO BE 100Ø UPVC SET AT MIN 1:60 FALLS. TO DISCHARGE INTO MUNICIPAL

ALL WASTE PIPES TO BE Ø50mm PVC TO DISCHARGE INTO P.C. GULLY UNLESS OTHERWISE STATED. INSPECTION EYES TO BE PROVIDED AT ALL JUNCTIONS AND BENDS. ALL VENT PIPES TO DISCHARGE TO THE OPEN AIR.

STORM WATER TO BE DISCHARGED IN ACCORD. WITH SABS 044 PART R ALL TO DISCHARGE AS SHOWN ON PLAN

LIGHTING, VENTILATION & GLAZING ALL LIGHTING & VENTILATION MUST COMPLY WITH NBR SABS 0400 PART 0 GLAZING OF WINDOWS TO COMPLY WITH NBR SABS 0400 PART NN2 & NN3

STAIR WAYS & BALUSTRADE: ALL STAIRWAYS TO COMPLY WITH NBR. SABS 0400 PART M ALL BALUSTRADES, HANDRAILS TO COMPLY WITH NBR. SABS 0400 PART MM3 & DD2,4 AND ARE TO

HAVE A MIN. HEIGHT OF 1000mm

FIRE NOTES:

OCCUPANCY CLASSIFICATION: F2, G1 & J3 ALL FIRE FIGHTING PROVISION TO BE IN ACCORDANCE WITH SABS NBR 0400 SECTION T FIRE DOORS TO COMPLY WITH SECTION TT34 OF SABS 0400-1990 FIRE HOSE REELS TO COMPLY WITH SECTION TT34 OF SABS 0400-1990 FIRE EXTINGUISHERS TO COMPLY WITH SECTION TT37 OF SABS 0400-1990

ALL RELEVANT SIGNS AS REQUIRED SHALL BE PROVIDED IN ACCORDANCE WITH CLAUSE SS9 OF PART S OF SABS 0400-1990

REFUSE AREA:

REFUSE AREA TO COMPLY WITH SECTION UU OF SABS 0400-1990 REFUSE BIN AREA GRADED TO SUMP WITH TAP PROVIDED

SITE AREA PERMITTED FAR 8.01:1, 3.0:1 PERMITED COERAGE NA PARKING REQUIREMENTS: EXISTNG GROUND FLOOR AREA EXISTNG FIRST FLOOR AREA 734.91m² TOTAL EXISTNG FLOOR AREA NEW GROUND FLOOR AREA NEW FIRST FLOOR AREA

SCHEDULE OF AREAS:

 $740,088m^2 + 345,213m^2 = 1085.3m^2$ 46.39m² TOTAL ADDITIONAL FLOOR AREA -53.31m² TOTAL NEW FLOOR AREA

1. DO NOT SCALE THIS DRAWING 2. WORK IN FIGURED DIMENSIONS ONLY. 3. ANY DISCREPANCIES ON THIS DRAWING TO BE BROUGHT TO THE ARCHITECTS/ ENGINEERS ATTENTION PRIOR TO IMPLEMENTATION OF ANY WORK. 4. ALL CONSTRUCTION WORK TO BE IN COMPLIANCE WITH NATIONAL BUILDING REGULATIONS SABS 0400 5. THE COPYRIGHT OF THIS DRAWING REST WITH HUIZINGA ARCHITECTS.

Owner's signature: Architect's signature:

HUIZINGA ARCHITECTS

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Rem & Ptn 1 of Lot 10063 Durban

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082 928 7624 or 031 303 9294

Submission **Roof Plan**

Drawn By: E. Huizinga

Scale: 1:100, ' MGATE SUB-03