


Garage South East Elevation

1:100

Garage/Ancillary Unit South West Elevation

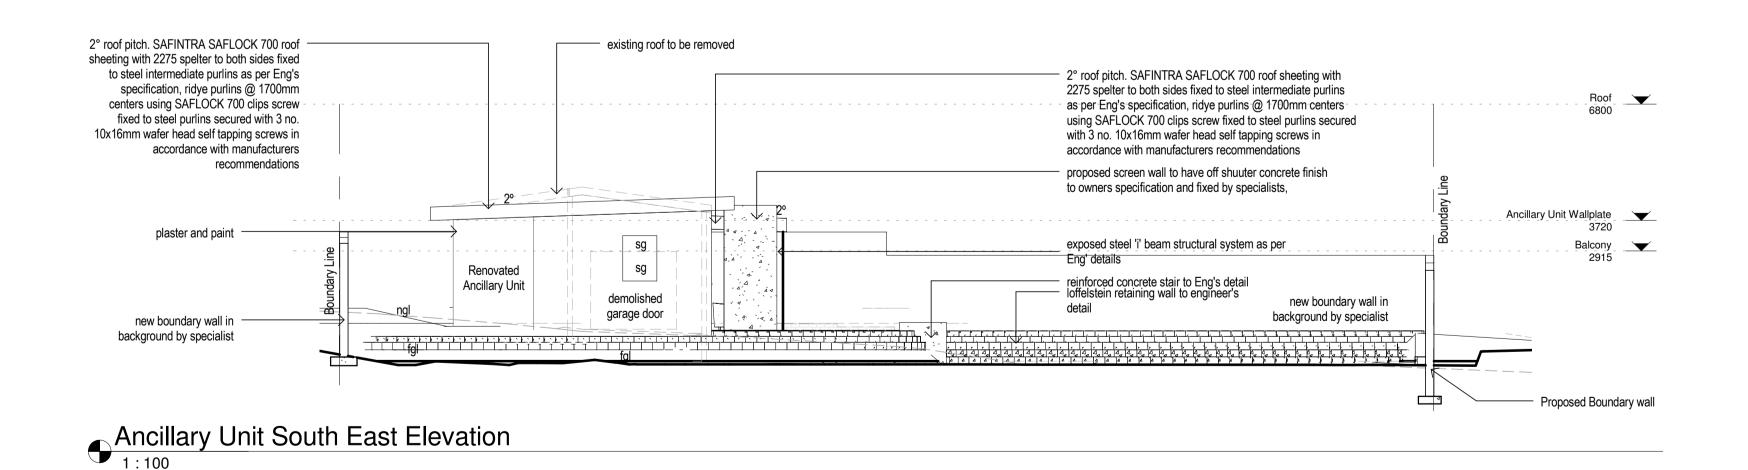

NEIGBOURS DETAILS	NEIGBOURS DETAILS	NEIGBOURS DETAILS	NEIGBOURS DETAILS
NAME :	NAME :	NAME :	NAME :
) NO. :	ID NO. :	ID NO. :	ID NO. :
DDRESS :	ADDRESS :	ADDRESS :	ADDRESS :
EL. :	TEL. :	TEL. :	TEL. :
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EIGBOURS DETAILS	NEIGBOURS DETAILS	NEIGBOURS DETAILS	NEIGBOURS DETAILS
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construction notes

*2° roof pitch. SAFINTRA SAFLOCK 700 roof sheeting with 2275 spelter to both sides fixed to steel intermediate purlins as per Eng's specification, ridye purlins @ 1700mm centers using SAFLOCK 700 clips screw fixed to steel purlins secured with 3 no. 10x16mm wafer head self tapping screws in accordance with manufacturers recommendations *all fascias, bargeboards and roof trims to be fibre cement painted white (to architects selection). * flashing: steel flashing painted plascon all rainwater goods to be white (to architects selection) consisting of gutters and aluminum

*ceilings: internal to be gypsumskimmed rhinoboard, with taped joints, on 38 x 38 softwood brandering. *external to be painted fibre cement, with taped joints, on 38 x 38 softwood brandering.

WALL *all plaster work to be rendered smooth. *all eternal brickwork to have outside face of internal skin bagged and bitumised. *two courses brickforce to be provided at slab, cill and wall plate level. *p.c lintols to be provided at all openings. *stepped dpc's to all cills and above all openings.

FLOOR *ground floor: mesreinforced concrete surface bed, to be certified by an Engineer, on approved damp proof membrane on well consolidated and poisoned soil.

FOUNDATIONS *all foundations to pr. Engineers detail.

STORMWATER *all stormwater pipe sizing, sumps and layouts to pr. Engineers detail.

RESPECT OF S. A. STANDARD CODE OF PRACTICE FOR THE APPLICATION OF THE NATIONAL BUILDING REGULATIONS, SANS 10400:2010

GENERAL ·sanitary fixtures to be required by the Machinery Occupational Safety Act (act 6 of 1983) ·all underground ducts, pipes & vents to be adequately sealed against methane seepage. ·all slabs, foundations & structural steel to engineer's details premises to be rendered rodent proof in accordance with

PART D: PUBLIC SAFETY ·all Public Safety to comply with SANS 10400-D: 2011 ·all swimming pool & swimming baths to comply with annex D4

PART M: STAIRWAYS ·dimensions of stairways to comply with MM2 ·all balustrading to be minimum 1000mm high to comply with

·all treads to be minimum 250mm wide & risers to be maximum

200mm high

PART N: GLAZING all glazing to comply with SANS 10400-N: 2010, as follows: doors:6.5mm laminated safety glass or 6mm for less then 1 sqm ·windows:3mm for areas less then 0.75 sqm 4mm for areas less then 1.5 sqm

6mm for areas more then 1.5 sqm

PART O: LIGHTING & VENTILATION ·all lighting & ventilation comply with SANS 10400-O: 2011 and Part 01 Lighting & Ventilation Requirement and Part 02 Special

Provision of Natural Lighting as well Part 07 Fire requirements

ELECTRICAL ·all electrical installations shall be carried out strictly in accordance with latest edition of: ·SABS 0142: code of practice for the wiring of premises; SABS 0114: code of practice for interior artificial lighting Part 1 & O of SANS 10400 ·SABS 0400: emergency lighting;

the Municipal by-laws & special requirements of the local supply authority: Telkom: regulations of the Department of Posts and Telecommunications;

·the Occupational Health & Safety Act No. 85 of 1993; regulations of the Local Gas Board PART T: FIRE PROTECTION

·all fire protection to comply with SANS 10400-T: 2011 all openings to be protection compliance with T: 4.10 all ceilings to comply with T: 4.13 all floor coverings to comply with T: 4.14 ·all internal finishes to comply with T: 4.15 all services in structural or separating elements to comply with T: ·all building materials to comply with T: 4.56



ARCHITECT

Proposed Additions and Alterations, Garage and Ancillary Unit to dwelling for Mr B Coucom at 667 Andrew Zondo Road, Athlone Park, **ERF 1172 of AMANZIMTOTI** EXT 3

SACAP 6972

SUBMISSION DRAWINGS elevations

RATE NO.: 70-02508074-0



Scale 1 : 100	Date January 2013	Drawn By B.S	
Proj No. 1206-01	DWG NO. la_201	Rev. -	